Form 3160-3 (September 2001)

UNITED STATES DEPARTMENT OF THE INTERIOR BUREAU OF LAND MANAGEMENT

FORM APPROVED OMB No. 1004-0136 Expires January 31, 2004

5. Lease Serial No.

UTU-66761

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ъ.	If Indian, Allottee or Tribe Name
i	A 1/4

APPLICATION FOR PERMIT TO DR	N/A				
1a. Type of Work: DRILL REENTER	7. If Unit or CA Agreeme				
lb. Type of Well: Oil Well 🗹 Gas Well 🚨 Other	8. Lease Name and Well Rainbow 11-				
2. Name of Operator McElvain Oil & Gas Properties, Inc.	9. API Well No. 43 -047-	38249			
3a. Address 1050-17th Street, Ste. 1800 Denver, CO 80265		10. Field and Pool, or Exp	d		
4. Location of Well (Report location clearly and in accordance with a At surface 2018' FNL & 2158' FWL (SENW) Sec. 23 At proposed prod. zone same (vertical well)	3, T11S-R		>	11. Sec., T., R., M., or Blk Sec. 23, T11S-F	. and Survey or Area
14. Distance in miles and direction from nearest town or post office* 20 miles South of Bonanza, Utah			•	12. County or Parish Uintah County	13. State Utah
15. Distance from proposed* location to nearest 2,158 ft. W. of lease/unit line property or lease line, ft. (Also to nearest drig. unit line, if any)		Acres in lease 2,494.86	17. Spacing Unit dedicated to this well 40 Acres		
 Distance from proposed location* to nearest well, drilling, completed, applied for, on this lease, ft. Topo "C" 1 mi radius	19. Propos	ed Depth 6,575 ft		/BIA Bond No. on file PM 4138223 (Nation-Wide Bond)	
21. Elevations (Show whether DF, KDB, RT, GL, etc.) 6,016.9' GL	22. Approx	. Approximate date work will start* 23. Estimated durat October 2006 30 Days Co			uction & Drilling
		achments			
 The following, completed in accordance with the requirements of Onshore Well plat certified by a registered surveyor. A Drilling Plan. A Surface Use Plan (if the location is on National Forest System I SUPO shall be filed with the appropriate Forest Service Office). 		4. Bond to cover the litem 20 above). 5. Operator certifice.	ne operatio ation. specific inf	s form; ns unless covered by an existence of the second control o	
25. Signature	Name	(Printed/Typed) Barbara Mari	in	Dat	June 2, 2006
Engineer Approved by Storatory		e (Printed/Typed) BRADLEY G.	HILL	Da	te 6-15-06
Title Title		ENVIRONMENTAL M		10	- 10 00

Application approval does not warrant or certify the the applicant holds legal or equitable title to those rights in the subject lease which would entitle the applicant to conduct operations thereon.

Conditions of approval, if any, are attached.

Title 18 U.S.C. Section 1001 and Title 43 U.S.C. Section 1212, make it a crime for any person knowingly and willfully to make to any department or agency of the United States any false, fictitious or fraudulent statements or representations as to any matter within its jurisdiction.

*(Instructions on reverse)

RECEIVED JUN 0 8 2006

T11S, R24E, S.L.B.&M.

S89'56'W - 79.98 (G.L.O.) S89°59'32"W - 2626.48' (Meas.) N89'33'48"W - 2640.79' (Meas.) Set Stone Set Stone Set Stone (Measured) 'Basis of Bearings) 2616.t 2158 ,00.00N (C.L.O.) NO0*01'W (G.L.O.) Drilling Window N00.01'W Set Stone WELL LOCATION: RAINBOW 11-24-22-23 ELEV. UNGRADED GROUND = 6024.3' W.25.20.00V Set Stone Set Stone Set Stone S89°57'58"W - 2645.82' (Meas.) S89°53'21"W - 2633.08' (Meas.)

S89*57'W - 80.04 (G.L.O.)

=

= SECTION CORNERS LOCATED

BASIS OF ELEV; U.S.G.S. 7-1/2 min QUAD (RAINBOW)

RAINBOW 11-24-22-23 (Surface Location) NAD 83 LATITUDE = 39. 50. 57.27." LONGITUDE = 109. 11. 59.98."

ENDURING RESOURCES

WELL LOCATION, RAINBOW 11-24-22-23, LOCATED AS SHOWN IN THE SE 1/4 NW 1/4 OF SECTION 23, T11S, R24E, S.L.B.&M. UINTAH COUNTY, UTAH.



REGISTERED LAND SURVEYOR
RICISTRA PONUNO. PROSECUE OF BEAM TE OF

TRI STATE LAND SURVEYING & CONSULTING

180 NORTH VERNAL AVE. - VERNAL, UTAH 84078 (435) 781-2501

DATE DRAWN: 1-12-06	SURVEYED BY: J.H.	SHEET
REVISED:	DRAWN BY: M.W.	2
NOTES:	SCALE: 1" = 1000'	OF 9

McELVAIN OIL & GAS PROPERTIES, INC.

Rainbow 11-24-22-23
Surface Location: SENW Sec. 23-T11S-R24E
BH Location: SENW Sec. 23-T11S-R24E
Uintah County, Utah

Lease #: UTU-66761

ONSHORE ORDER 1 - DRILLING PLAN

1. <u>Estimated Tops of Geological Markers:</u>

Ungraded Ground Level Elevation: 6,024.3' Graded Ground Level Elevation: 6,016.9' Estimated KB Elevation: (16') 6,033'

Formation	Drill Depth	Subsea Depth (KB)
Uinta	Surface	
Green River	306'	+ 5,727
Wasatch	2,583'	+ 3,450
Mesaverde	3,958'	+ 2,075
Buck Tongue	6,080'	- 47
Castlegate	6,111'	- 78
TD	6,575'	

2. Estimated Depths of Anticipated Water, Oil, Gas or Other Minerals:

Formation	Drill Depth	Anticipated Fluids
Uinta	Surface	
Green River	306'	Gas, Water, Oil
Wasatch	2,583'	Gas, Water
Mesaverde	3,958'	Gas, Water, Oil
Buck Tongue	6,080'	Gas, Water, Oil
TD	6,575'	

An 11" hole will be drilled to approximately 2000 feet. The depth will be determined by the depth that the Birds Nest zone is encountered. The hole will be drilled 400 feet beyond the top of the Birds Nest zone and surface casing will be set.

3. Pressure Control Equipment: (3000 psi schematic attached)

A. Type: Eleven (11) inch double gate hydraulic BOP with eleven (11) inch annular preventer on 3,000 psi casinghead, with 3,000 psi choke manifold equipped per the attached diagram. BOPE as specified in *Onshore Oil & Gas Order Number 2*. A PVT, stroke counter and flow sensor will be installed to check for flow and monitor pit volume.

- Pressure Rating: 3,000 psi BOPE B.
- C. Kelly will be equipped with upper and lower Kelly valves.
- D. Testing Procedure: Annular Preventer

At a minimum, the annular preventer will be pressure tested to 50% of the stack rated working pressure for a period of ten (10) minutes or until provisions of the test are met, whichever is longer.

At a minimum, the above pressure test will be performed:

- When the annular preventer is initially installed: 1.
- 2. Whenever any seal subject to test pressure is broken:
- 3. Following related repairs; and
- 4. At thirty (30) day intervals.

In addition to the above, the annular preventer will be functionally operated at least weekly.

Blow-Out Preventer

At a minimum, the BOP, choke manifold, and related equipment will be pressure tested to the approved working pressure of the BOP stack (if isolated from the surface casing by a test plug) or to 70% of the internal yield strength of the surface casing (if the BOP is not isolated from the casing by a test plug). Pressure will be maintained for a period of at least ten (10) minutes or until the requirements of the test are met, whichever is longer.

At a minimum, the above pressure test will be performed:

- When the BOP is initially installed; 1.
- 2. Whenever any seal subject to test pressure is broken:
- 3. Following related repairs; and
- 4. At thirty (30) day intervals.

In addition to the above, the pipe and blind rams will be activated each trip, but not more than once each day. All BOP drills and tests will be recorded in the IADC driller's log.

E. Miscellaneous Information:

The blowout preventer and related pressure control equipment will be installed, tested and maintained in compliance with the specifications in and requirements of Onshore Oil & Gas Order Number 2.

4. **Proposed Casing & Cementing Program:**

A. Casing Program: All New

Hole Size	Casing Size	Wt./Ft.	Grade	Joint	Depth Set
					(MD)
20"	14" O.D.				40' (GL)
11"	8-5/8"	24#	J-55	ST&C	0 – 2,000' (KB) est.

<u>McElvai</u>	in Oil & Gas	Rainbow 11-24-22-23				Page	<u>- 3 -</u>
	7-7/8"	4-1/2"	11 6#	N-80	I T&C	0 - 6.575' (KB)	

The surface casing will have a thread locked guide shoe, 1 joint, insert float collar. At a minimum, the surface casing will have the bottom 3 joints centralized, starting with the shoe joint. Depending on hole conditions, a maximum of 8 bowspring centralizers may be utilized.

All casing strings below the conductor will be pressure tested to 0.22 psi/foot of casing string length or 1500 psi, whichever is greater (not to exceed 70% of the internal yield strength of the casing).

B. Casing Design Parameters:

Depth (MD)	Casing	Collapse(psi)/SF	Burst (psi)/SF	Tension(mlbs)/SF
40' (GL)	14" OD			
2000' (KB)	8-5/8", 24#/ft, J55, STC	1370/1.5 (a)	2950/3.2(b)	244/5.8 (c)
6575' (KB)	4-1/2", 11.6#/ft, N-80, LTC	6350/1.9 (d)	7780/2.3 (e)	223/3.4 (f)

Safety Factor (SF) estimated using the following criteria:

- (a.) based on full evacuation of pipe with 8.6 ppg fluid on annulus
- (b.) based on 8.6 ppg gradient with no fluid on annulus
- (c.) based on casing string weight in 8.6 ppg mud
- (d.) based on full evacuation of pipe with 10.0 ppg fluid on annulus
- (e.) based on estimated BHP (0.52 psi/ft gradient) @ surface. No annular fluid
- (f.) based on casing string weight in 9.2 ppg mud

PROPOSED CEMENTING PROGRAM

Surface Casing (if well will circulate)-Cemented to surface

CASING	SLURRY	FT. of FILL	CEMENT TYPE	sxs	EXCESS (%)	WEIGHT (ppg)	YIELD (ft ³ /sx)
8-5/8"	Lead	1500	Premium cement + 16% gel + 0.25 pps celloflake	140	25%	11.1	3.50
8-5/8"	Tail	500	Premium cement + 2% CaC ₂ + 0.25 pps celloflake	150	25%	15.8	1.15

If a cement top job is required due to cement fallback greater than 10' below ground level, the top job cement will be a premium cement (weight 15.8 ppg, yield 1.15 ft^3/sx) w/3% CaCl₂ + 0.25 pps celloflake. The top job volume will cement to surface.

Surface Casing (if well will not circulate) - Cemented to surface

CASING	SLURRY	FT. of FILL	CEMENT TYPE	sxs	EXCESS (%)	WEIGHT (ppg)	YIELD (ft ³ /sx)
8-5/8"	Lead	500	Premium cement + 2% CaCl ₂ + 0.25 pps celloflake	150	25	15.8	1.15
8-5/8"	Top job	As req.	Premium cement + 3% CaCl ₂ + 0.25 pps celloflake	As Req.		15.8	1.15

Production Casing and Liner - Cemented TD to 300' above base of surface casing

CASING	SLURRY	FT.	CEMENT TYPE	SXS	EXCESS	WEIGHT	YIELD
		of FILL		(+/-)	(%)	(ppg)	(ft ³ /sx)
4-1/2"	Lead	500	Class "G" + 5% NaCl + 12% Gel + 0.25 pps celloflake + 0.2% antifoam + 0.25% fluid loss + 1% extender	60	25	11.0	3.3
4-1/2"	Tail	4375	50/50 POZ Class G + 2% gel +1% CaCl ₂ + 0.2% dispersant + 0.2% fluid loss + 0.1% antifoam	800	25	14.3	1.56

Cement volumes for the 4-1/2" Production Casing will be calculated to provide a top of cement to 300' above base of surface casing. Cement volumes are approximate and were calculated under the assumption that a gauge hole will be achieved. Actual cement volumes may vary due to variations in the actual hole size and will be determined by running a caliper log on the drilled hole. Actual cement types may vary due to hole conditions and cement contractor used.

All waiting on cement (WOC) times will be adequate to achieve a minimum of 500 psi compressive strength at the casing shoe prior to drilling out.

5. <u>Drilling Fluids (mud) Program:</u>

Interval (MD)	Mud Weight	Fluid Loss	Viscosity	Mud Type
0' - 2000' (KB)		No cntrl		Air/mist
2000'-2200' (KB)	8.4-8.6	No cntrl	28-36	Water
2200'-6575' (KB)	8.8-10.2	8 - 10 ml	32-42	Water/Gel

Sufficient mud material(s) to maintain mud properties, control lost circulation and contain a blowout will be available at the well site during drilling operations.

6. Evaluation Program:

Inclination Survey: Single shot drift surveys will be dropped or "teledrift" surveys

performed every 2000 feet of hole to monitor hole angle.

Tests: No tests are currently planned.

<u>Coring:</u> No cores are currently planned.

<u>Samples:</u> No sampling is currently planned.

Logging

- Dual Induction SFL /Gamma Ray/Caliper/SP/TDLT/CNL/ML TD to Base Surface Casing
- Cement Bond Log / Gamma Ray:
 TD to Base of Surface Casing or Top of Cement if below Base of Surface Casing

Stimulation: A stimulation or frac treatment will be designed for completion of this well based on openhole log analysis. The drill site, as approved, will be sufficient size to accommodate all completion activities.

7. <u>Abnormal Conditions:</u>

No abnormal temperatures are anticipated. No H₂S has been encountered or known to exist from previous wells drilled to similar depths in the general area.

Anticipated bottom hole pressure may be slightly above normal (estimated calculation at 0.52 psi/foot) and is estimated to be 3,400 psi and maximum anticipated surface pressure equals approximately 2,000 psi (anticipated bottom hole pressure minus the pressure of a partially evacuated hole is estimated to be 0.22 psi/foot of hole).

8. <u>Anticipated Starting Dates:</u>

• Anticipated Commencement Date- Within one year of APD issue.

Drilling Days Completion Days Approximately 20 days
 Approximately 30 days

Anticipate location construction within 30 days before rig move.

9. <u>Variances:</u>


None anticipated

10. Other:

A Cultural Resource Inventory and Paleontology reconnaissance shall be conducted for the well location, access road and pipeline route. The reports shall be submitted to the Vernal Field Office of the Bureau of Land Management upon their receipt.


PRESSURE CONTROL

BOP Assembly

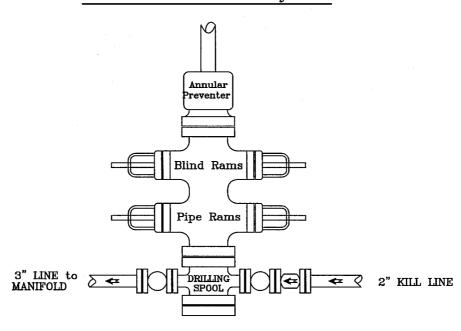

Preventer, Rams and Spool are to have a 9" Bore or larger and a 3000 PSI or higher Pressure Rating

Choke Manifold

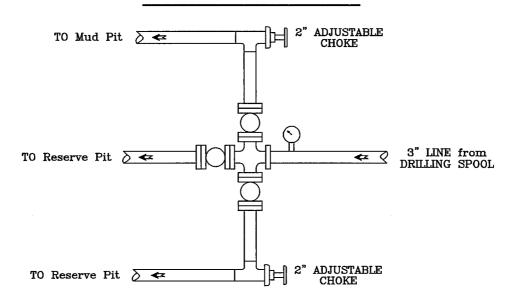

McElvain Oil & Gas Properties, Inc.

MCELVAIN OIL & GAS PROPERTIES, INC.

Rainbow 11-24-22-23 SENW Sec 23-T11S-R24E Uintah County, Utah

Lease #: UTU-66761

ONSHORE OIL & GAS ORDER NO. 1 MULTI-POINT SURFACE USE & OPERATIONS PLAN

1. Existing Roads:

Directions to the proposed location are as follows:

PROCEED EAST AND SOUTHEAST FROM VERNAL ON HIGHWAY 40 TO HIGHWAY 45 AT NAPLES, UTAH WHERE A SIGN INDICATES THE DIRECTION TO BONANZA POWER PLANT. RIGHT (SOUTH) ± 36 MILES ON HIGHWAY 45 TO BONANZA, UTAH. PROCEED SOUTH (PAST BONANZA AND WHITE RIVER) ON HIGHWAY 45 AN ADDITIONAL ± 5 MILES TO MILE MARKER "0". LEFT (SOUTHEAST) AT MILE MARKER "0" ON GRAVEL ROAD. BLM SIGN INDICATES THIS IS THE ACCESS ROAD LEADING TO "RAINBOW JUNCTION" AND "BAXTER PASS" (UINTAH COUNTY RD #4180) PROCEED SOUTH/SOUTHEAST ON GRAVEL ROAD APPROXIMATELY 3.7 MILES TO A "Y" IN THE ROAD AT CORRALS KNOWN AS THE "GREEK" CORRALS. RIGHT AT THE "Y" BY THE "CREEK" CORRALS TOWARDS ATCHEE RIDGE & RAINBOW (UINTAH COUNTY RD #4190). PROCEED ± 8.5 MILES TO A JUNCTION. LEFT AT THE JUNCTION TOWARDS KINGS WELLS ROAD ON UINTAH COUNTY RD # 4190. PROCEED ± 1.2 MILES TO LOCATION ACCESS ROAD. RIGHT OFF COUNTY RD # 4190 ONTO LOCATION.

2. Planned Access Roads:

The proposed 2660 feet of new construction for the access road indicated on TOPO MAP "B" will include approximately 2660 feet of new ON-LEASE construction in Sections 23 of T11S-R24E, and 820 feet of new OFF-LEASE access road construction in Section 23 of T11S-R24E. Bladed, ditched and crowned County Class B roads will be utilized up to the start of the new construction and no upgrading will be required on these County roads.

Please refer to Topo Map "B" for the takeoff point from the existing County Class B road to the new wellsite location.

The proposed access road will be utilized to transport personnel, equipment and supplies to and from the proposed well site during drilling, completion and production operations. The road will be utilized year round.

The access road will be crowned 2% to 3%, ditched and constructed with a running surface of 18 feet and a maximum disturbed width of 30 feet right-of-way. Maximum

grade of road is 5% or less. Graveling or capping the roadbed will be performed as necessary to provided a well constructed, safe road. No fence crossings, culverts, turnouts, cattle guards or major cuts and fills are required. Prior to construction or upgrading, the proposed road shall be cleared of any snow and allowed to dry completely.

Surface disturbance and vehicular traffic will be limited to the proposed location and proposed access route. Any additional area needed will be approved in advance. All construction shall be in conformance with the standards outlined in the BLM and Forest Service publication: Surface Operating Standards for Oil and Gas Exploration and Development. 1989.

The road surface and shoulders will be kept in a safe usable condition and will be maintained in accordance with the original construction standards. All drainage ditches will be kept clear and free flowing and will be maintained according to original construction standards. The access road surface will be kept free of trash during operations. All traffic will be confined to the approved disturbed surface. Road drainage crossings shall be designed so they will not cause siltation or accumulation of debris in the drainage crossing nor shall the drainages be blocked by the road bed. Erosion of drainage ditches by runoff water shall be prevented by diverting water off at frequent intervals by means of cutouts. Upgrading shall not be allowed during muddy conditions. Should mud holes develop, they shall be filled in and detours around them avoided. When snow is removed from the road during the winter months, the snow shall be pushed outside of the borrow ditches and the turnouts kept clear so that snowmelt will be channeled away from the road.

3. <u>Location of Existing Wells within a One-Mile radius:</u>

The following wells are wells located within a one (1) mile radius of the proposed location.

Water Wells:	NONE
Injection Wells:	NONE
Producing Wells:	ONE
1) Thimble Rock 23-15, S	Sec 23, T11S-R24E
Drilling Wells:	NONE
Shut-in Wells:	NONE
Temporarily Abandoned Wells:	NONE
Disposal Wells:	NONE
Abandoned Wells:	NONE
Dry Holes:	NONE
Observation Wells:	NONE
	Injection Wells: Producing Wells: 1) Thimble Rock 23-15, S Drilling Wells: Shut-in Wells: Temporarily Abandoned Wells: Disposal Wells: Abandoned Wells: Dry Holes:

4. Location of Existing and/or Proposed Facilities:

All production facilities will be located on the disturbed portion of the well pad and at a minimum of 25 feet from the toe of the back slope or the top of the fill slope.

A dike will be constructed completely around those production facilities which contain fluids (i.e. production tanks, produced water tanks and/or heater treater). These dikes will be constructed of compacted subsoil, be impervious, hold 100% of the capacity of the largest tank and be independent of the back cut.

All permanent (on site for six months or longer) above the ground structures constructed or installed, including pumping units, will be painted a flat, non-reflective, earth tone color to match one of the standard environmental colors, as determined by the rocky Mountain Five State Inter-Agency Committee

All facilities will be painted within 6 months of installation. Facilities required to comply with the Occupational Safety and Health Act (OSHA) will be excluded.

Any necessary pits will be properly fenced to protect livestock and prevent wildlife entry.

If the well is capable of economic production, a surface gas gathering line and related equipment shall be installed. The surface gas gathering line shall be in use year round. A total of approximately 3480 feet of surface gas gathering pipeline shall be laid on the surface to minimize surface disturbance:

- a. ON-LEASE approximately 2660 feet, and
- b. OFF-LEASE approximately 820 feet of 6 inch or less diameter steel, unpainted, welded gas gathering line is proposed.

The proposed gathering line will be placed above ground adjacent to the proposed access route. The line will be welded together and pulled from the beginning point to the tie-in point when practical; however, it may be necessary to utilize the access road for welding of the line. The line will then be boomed off to the side of the road. The gas meter run will be located ON-LEASE and within 500 feet of the wellhead. The meter run will be housed.

Upon plugging and abandonment, the gas gathering line will be removed and the disturbed area will be re-contoured and restored as near as practical to the original condition. If necessary, re-seeding operations will be performed after completion of other reclamation operations.

5. Location and Type of Water Supply:

Water will be obtained from the White River by Tu and Frum, Inc. Water User Claim #49-2185, Application #T75517, or by Target Trucking Water User Claim #43-2195, or by Dalbo Inc. Water User Claim #43-8496

No water well is to be drilled on this lease.

6 Source of Construction Materials:

All construction material for this location site and access road shall be borrowed material accumulated during construction of the location site and access road. Additional road gravels or pit lining material will be obtained from private sources.

7. <u>Methods of Handling Waste Materials:</u>

Drill cuttings will be contained and buried in the reserve pit.

Drilling fluids, including salts and chemicals, will be contained in the reserve pit and will be removed and disposed of at an approved waste disposal facility within 120 days after drilling is terminated.

The reserve pit will not be located where a flood hazard exits or surface runoff will destroy or damage the pit walls. The reserve pit will be constructed so that it will not leak, brake or allow discharge of liquids.

The reserve pit will be lined with ¼ felt and a minimum of 16 mm plastic with sufficient bedding used to cover any rocks. The liner will overlap the pit walls and be covered with dirt and/or rocks to hold it in place. No trash or scrap that could puncture the will be disposed of in the pit.

A chemical portable toilet will be furnished with the drilling rig. The toilet will be replaced periodically utilizing a licensed contractor to transport by truck the portable chemical toilet so that its contents can be delivered to the Vernal Wastewater Treatment Facility in accordance with state and county regulations.

Garbage, trash and other waste materials will be collected in a portable, self-contained, fully enclosed trash cage during operations. No trash well be burned on location.

All debris and other waste material not contained in the trash cage will be cleaned up and removed from the location immediately after removal of the drilling rig.

Any open pits will be fenced during the operations. The fencing will be maintained until such time as the pits are backfilled.

No chemicals subject to reporting under SARA Title III (hazardous materials) in an amount greater than 10,000 pounds will be used, produced, stored, transported or disposed of in association with the drilling, completion or testing of this well. Furthermore, no extremely hazardous substances, as defined in 40 CFR 355, in threshold planning quantities, will be used, produced, stored, transported or disposed of in association with the drilling, completion or testing of this well.

Produced oil will be stored in an oil tank and then hauled by truck to a crude purchaser facility. Any produced water from the proposed well will be contained in a water tank and will then be hauled by truck to an approved disposal site.

8. Ancillary Facilities:

During drilling operations, approximately 20 days, the site will be a manned camp. Three or four additional trailers will be on location to serve as the crews' housing and eating facilities. These will be located on the perimeter of the pad site within the topsoil stockpiles. Refer to Sheet 5.

9. Well Site Layout: (Refer to Sheets #3, #4, and #5)

The attached Location Layout Diagrams described drill pad cross-sections, cuts and fills and locations of the mud tanks, reserve pit, flare pit, pipe racks, trailer parking, spoil dirt stockpile(s) and surface material stockpiles(s).

Please see the attached diagram for rig orientation and access roads.

The top soil will stock-piled and reseeded at the time the location is constructed. Seeding will be of the type specified by the BLM in their "Conditions of Approval".

The top soil removed from the pit area will be store separately and will not be reseeded until the pit is reclaimed.

All pits shall be fence to the following minimum standards:

- a. 39 inch net wire shall be used with at least one strand of barbed wire on top of the net wire. Barbed wire is not necessary if pipe or some type of reinforcement rod is attached to the top of the entire fence.
- b. The net wire shall be no more than 2 inches above the ground. The barbed wire shall be 3 inches over the new wire. Total height of the fence shall be at least 42 inches.
- c. Corner posts shall be cemented and/or braced in such a manner to keep the fence tight at all times.
- d. Standard steel, wood or pipe posts shall be used between the corner braces. Maximum distance between any two fence posts shall be no greater than 16 feet.
- e. All wire shall be stretched by, using a stretching device, before it is attached to corner posts.
- f. The reserve pit fencing will be on three sides during drilling operations and on the fourth side when the rig moves off location. Pits will be fenced and maintained until cleanup.
- g. Location size may change prior to drilling the well due to the current rig availability. If the proposed location is not large enough to accommodate the drilling, the location will be re-surveyed and a Form 9 will be submitted.

10. Plans for Surface Reclamation:

Producing Location:

- a. Immediately upon well completion, the location and surrounding area will be cleared of all unused tubing, equipment, materials, trash and debris not required for production.
- b. Immediately upon well completion, any hydrocarbons in the pit shall be removed in accordance with 40CFR 3162.7.
- c. Before any dirt work associated with location restoration takes place, the reserve pit shall be as dry as possible. All debris in it will be removed. Other waste and spoil materials will be disposed of immediately upon completion of operations.
- d. The reserve pit and that portion of the location not needed for production facilities/operations will be re-contoured to the approximated natural contours. The reserve pit will be reclaimed within 90 days from the date of well completion, weather permitting.
- e. To prevent surface water(s) from standing (ponding) on the reclaimed reserve pit area, final reclamation of the reserve pit will consist of "mounding" the surface 3 feet above surrounding round surface to allow the reclaimed pit area to drain effectively.
- f. Upon completion of back filling, leveling and re-contouring, the stockpiled topsoil will be spread evenly over the reclaimed area(s).

Dry Hole/Abandoned Location:

- i. Abandoned well sites, roads and other disturbed areas will be restored as nearly as practical to their original condition. Where applicable, these conditions include the re-establishment of irrigation systems, the re-establishment of appropriate soil conditions and re-establishment of vegetation as specified.
- ii. All disturbed surfaces will be re-contoured to the approximated natural contours with reclamation of the well pad and access road to be performed as soon as practical after final abandonment. If necessary, re-seeding operations will be performed after completion of other reclamation operations.

11. Surface Ownership: Location, Access and Pipeline Route:

Wellsite: Bureau of Land management

Access: Bureau of Land management

Pipeline: Bureau of Land management

12. Other Information

On-site Inspection for Location, Access and Pipeline Route:

The on-site was conducted February 16, 2006.

Special Conditions of Approval:

Wildlife stipulations and possible activity restrictions will be detailed in the "Conditions of Approval" received with an approved Permit to Drill. Operator will comply with these all conditions of approval.

Archeology:

a. A Cultural Resource Inventory Report is pending and to be prepared by Montgomery Archaeological Consultants.

Paleontology:

a. A Paleontology Reconnaissance Report is pending and to be prepared by Intermountain Paleo-Consulting.

If, during operations, any archaeological or historical sites, or any objects of antiquity (subject to the Antiquities Act of June 8, 1906) are discovered, all operations which would affect such sites will be suspended and the discovery reported promptly to the surface management agency.

13. <u>Lessee's or Operator's Representative and Certification:</u>

Representatives:

Barbara Martin
Engineer
McElvain Oil & Gas Properties, Inc.
1050 – 17th Street, Suite 1800
Denver, Colorado 80265
Office Tel: 303-893-0933 xtn 345

Fax Tel: 303-893-0914 BarbaraM@McElvain.com Ivan Sadlier Production Foreman McElvain Oil & Gas Properties, Inc. P.O. Box 985

Vernal, Utah 84078 Cell #1: 435-828-0284 Cell #2: 435-828-0282 sadlier@easilink.com

Certification:

Certification: All lease and/or unit operations will be conducted in a manner that is fully compliant with all applicable laws, regulations, Onshore Oil and Gas Orders, the approved Plan of Operations and any applicable Notice to Lessees.

The Operator will be fully responsible for the actions of its subcontractors. A complete copy of the approved "Application for Permit to Drill" will be furnished to the field representative(s) to ensure compliance and shall be on location during all construction and drilling operations.

McElvain Oil & Gas Properties, Inc. is considered to be the operator of the subject well. McElvain Oil & Gas Properties, Inc. agrees to be responsible under the terms and conditions of the lease for the operations conducted upon leased lands.


Bond coverage pursuant to 43 DFR 3104 for the lease activities is being provided by the McElvain Oil & Gas Properties, Inc. BLM Nationwide bond #LPM4138223.

I hereby certify that I, or persons under my direct supervision, have inspected the proposed drill site and access route; that I am familiar with the conditions with currently exist; that the statement made in this plan are, to the best of my knowledge, true and correct; and that the work associated with the operations proposed herein will be performed by McElvain Oil & Gas Properties, Inc., its contractors and subcontractors in conformity with this plan and the terms and conditions under which it is approved.

Barbara Martin


Engineer

*Juni 6, 20*06 Date:

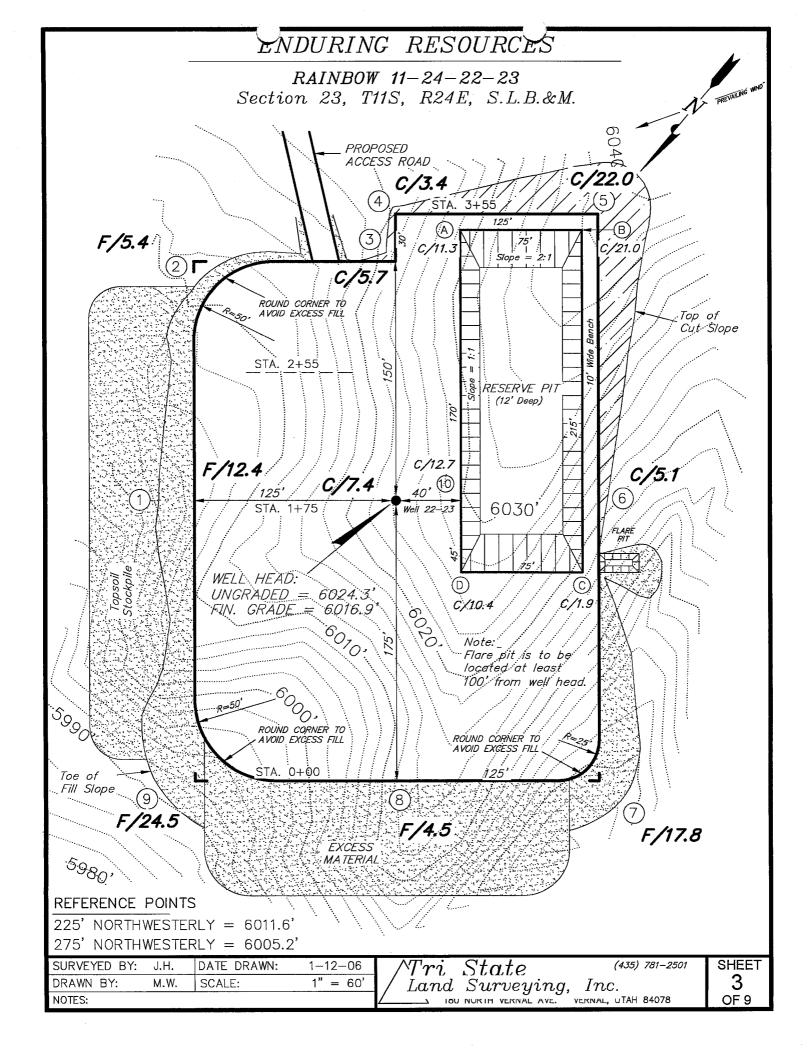

ENDURING RESOURCES CROSS SECTIONS RAINBOW 11-24-22-23 30, 11 1" = 60'STA. 3+55 30, STA. 2+55 1" = 60'**EXISTING** GRADE FINISHED GRADE 30, WELL HOLE II 1" = 60'STA. 1+75 30, 1" = 60'STA. 0+00 ESTIMATED EARTHWORK QUANTITIES (No Shrink or swell adjustments have been used) (Expressed in Cubic Yards) ITEM CUT FILL 6" TOPSOIL **EXCESS** Topsoil is not included in Pad Cut NOTE: PAD 16,780 16,740 40 UNLESS OTHERWISE NOTED PIT 5,390 0 5,390 CUT SLOPES ARE AT 1:1 FILL SLOPES ARE AT 1.5:1 TOTALS 22,170 16,740 1,980 5,430

SURVEYED BY: J.H.	DATE DRAWN:	1-12-06	Ari State	(435) 781–2501	SHEET
DRAWN BY: M.W.	SCALE:	1" = 60'	/ Land Surveying,	Inc.	4
NOTES:			, 0 0	VERNAL, UTAH 84078	OF 9

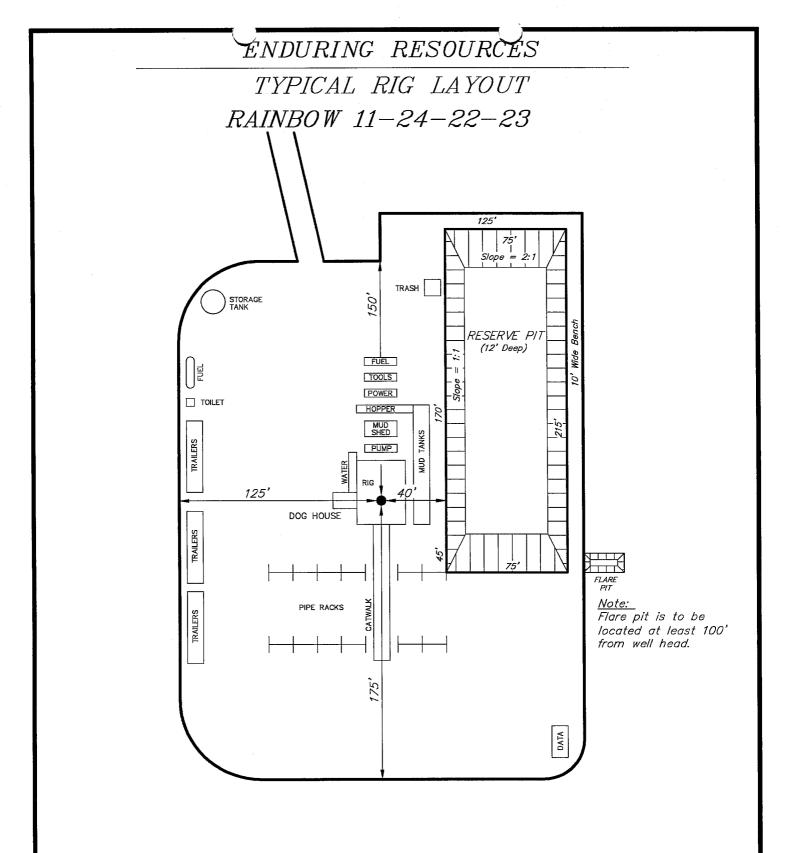


SURVEYED BY:	J.H.	DATE DRAWN:	1-12-06
DRAWN BY:	M.W.	SCALE:	1" = 60'
NOTES:			


	State	
Land	Surveying,	


d Surveying, Inc.
180 NORTH VERNAL AVE. VERNAL, UTAH 84078


(435) 781-2501


SHEET 5 OF 9

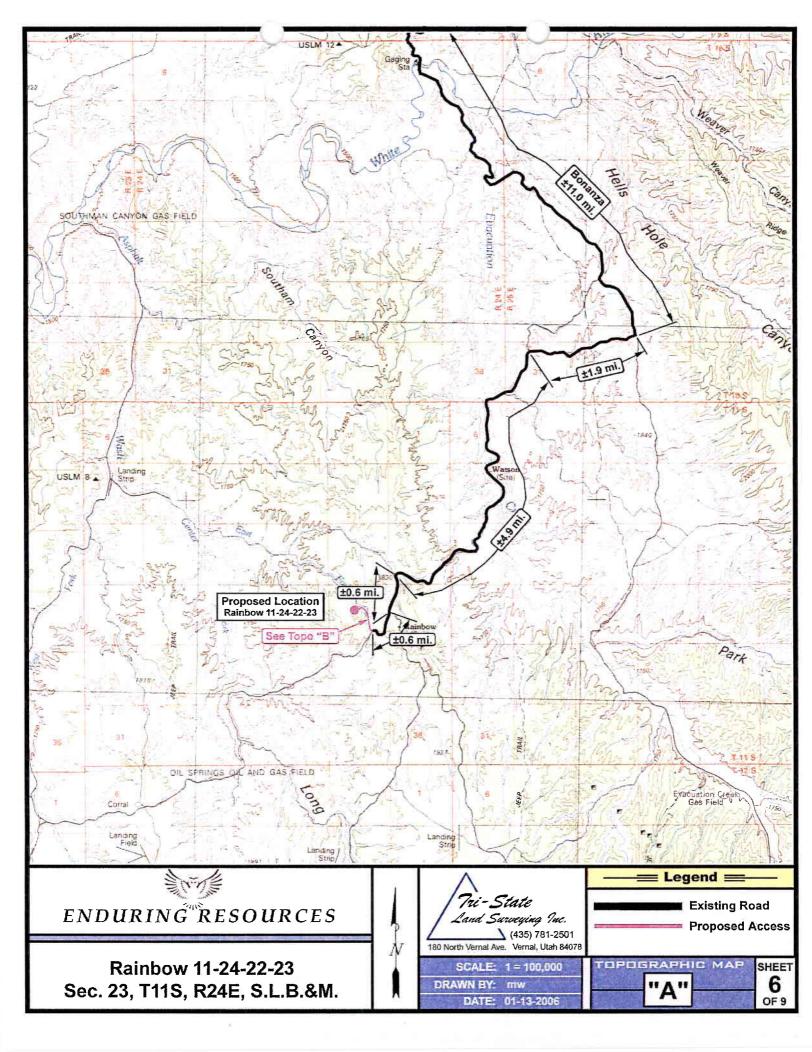

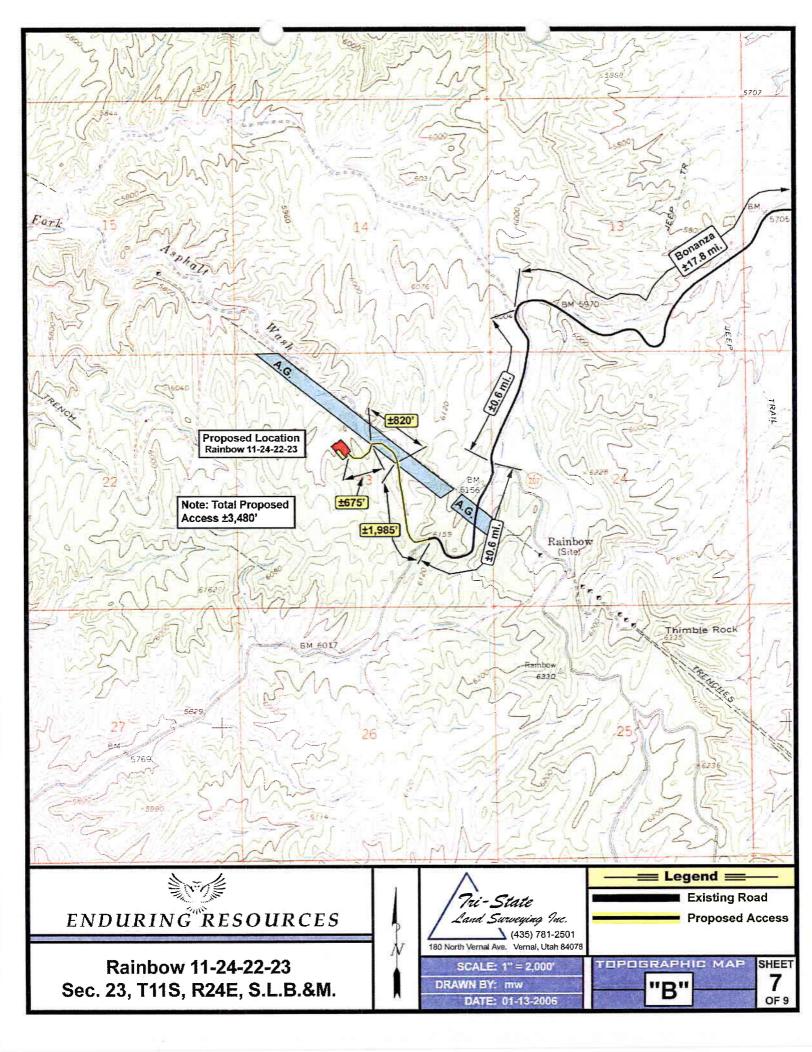

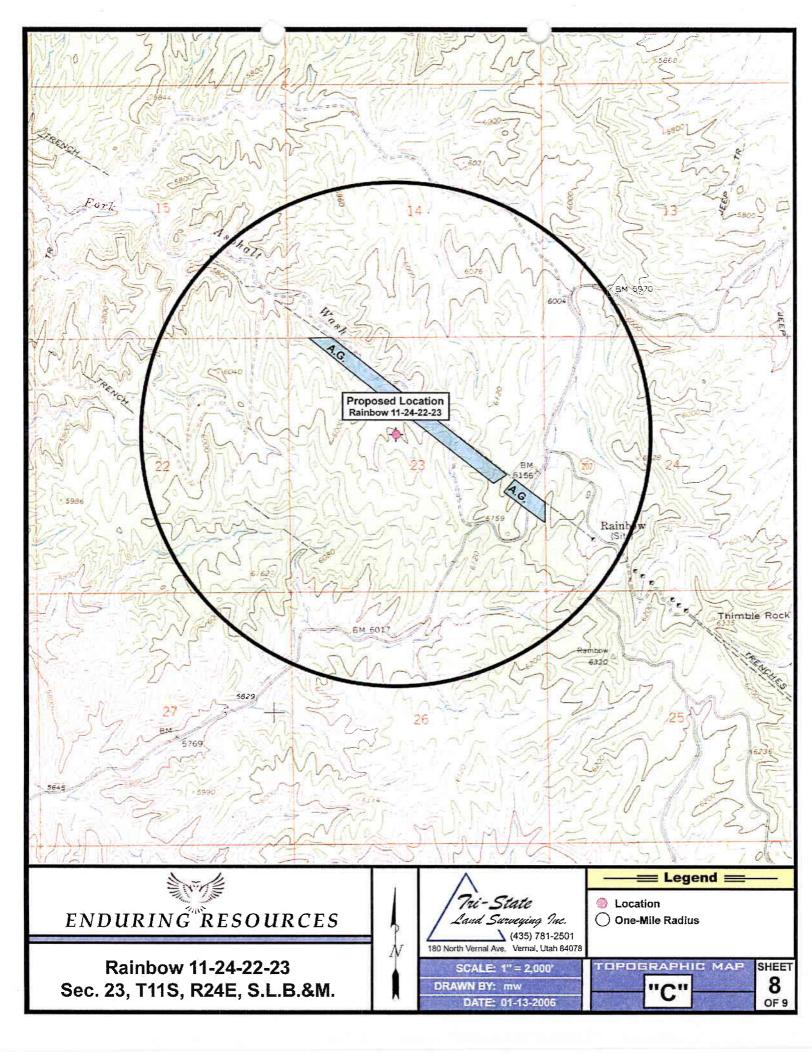

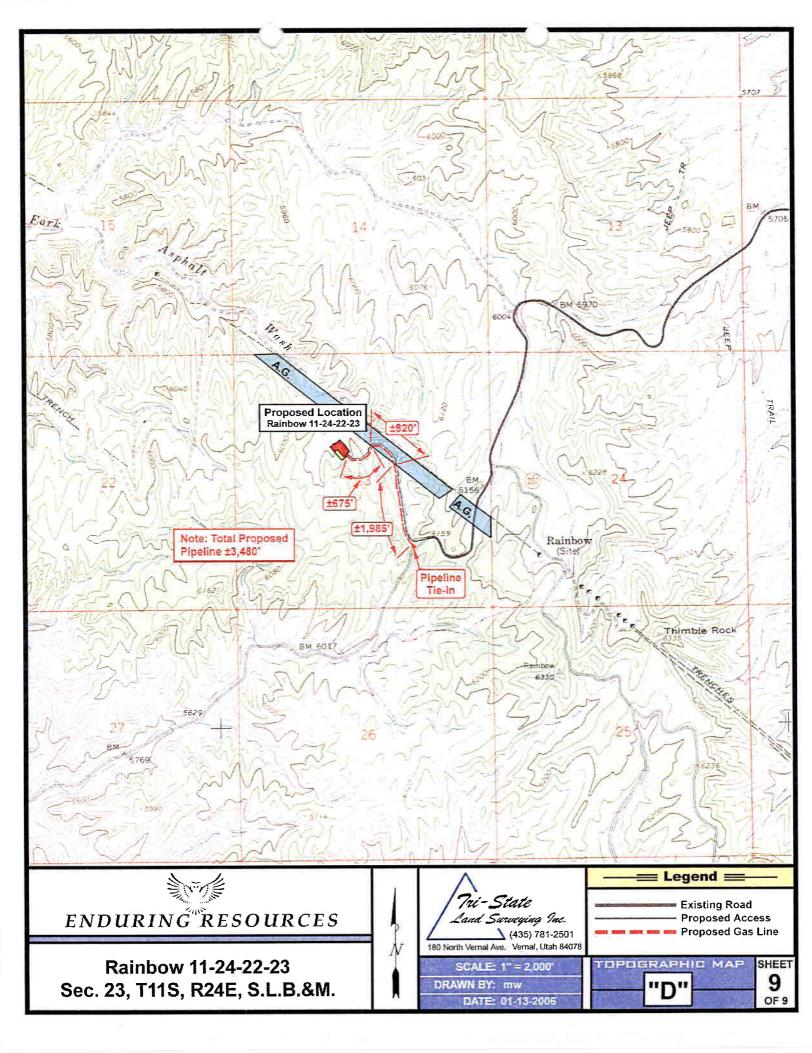

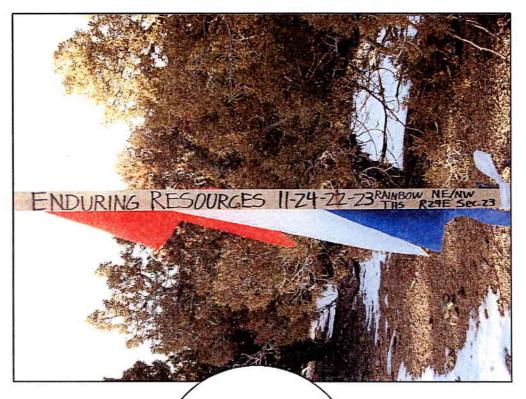

CENTER STAKE


ENDURING RESOURCES

Rainbow 11-24-22-23

Date Photographed: 01/10/2006

Date Drawn: 01/13/2006 Drawn By: mw Pri-State Land Surveying Inc.

(435) 781-2501 180 North Vernal Ave. Vernal, Utah 84078

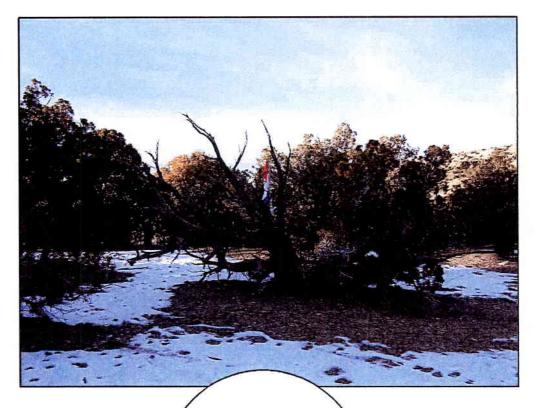

ENDURING RESOURCES

Rainbow 11-24-22-23

NORTH


Date Photographed: 01/10/2006

Date Drawn: 01/13/2006 Drawn By: mw

7ri-State Land Surveying Pac.
(435) 781-2501
180 North Vernal Ave. Vernal, Utah 84078

EAST



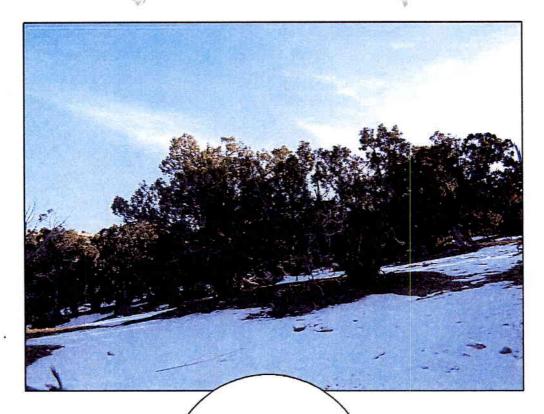

ENDURING RESOURCES

Rainbow 11-24-22-23


SOUTH


Date Photographed: 01/10/2006 Date Drawn: 01/13/2006 Drawn By: mw

Tri-State Land Surveying Inc.

435) 781-2501 180 North Vernal Ave. Vernal, Utah 84078


WEST

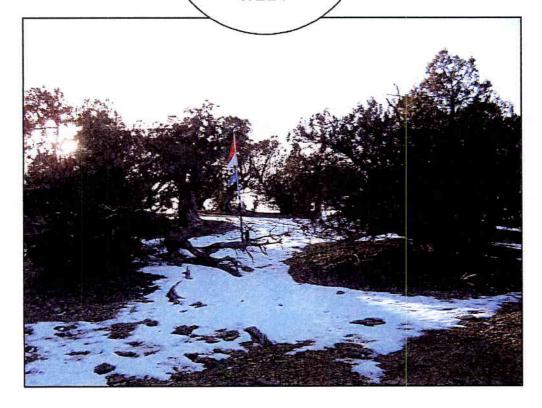

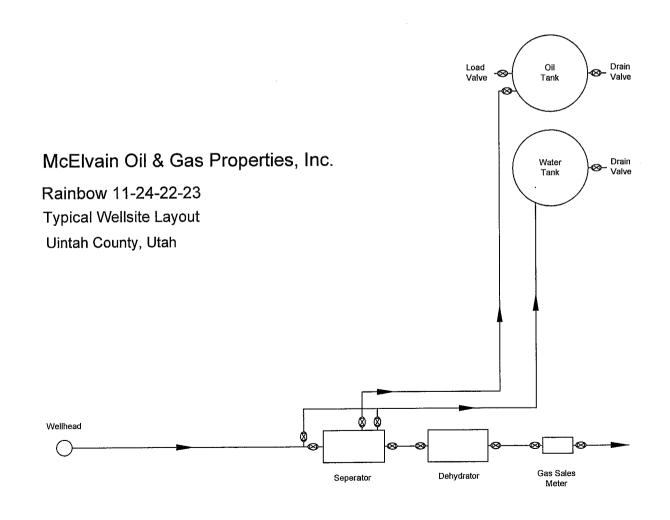

WORKSHEET APPLICATION FOR PERMIT TO DRILL

APD RECEIVED: 06/08/2006	API NO. ASSIGNED: 43-047-38249
WELL NAME: RAINBOW 11-24-22-23 OPERATOR: MCELVAIN OIL & GAS (N2100) CONTACT: BARBARA MARTIN	PHONE NUMBER: 303-893-0933
PROPOSED LOCATION:	INSPECT LOCATN BY: / /
SENW 23 110S 240E	Tech Review Initials Date
SURFACE: 2018 FNL 2158 FWL BOTTOM: 2018 FNL 2158 FWL	Engineering
COUNTY: UINTAH	Geology
LATITUDE: 39.84914 LONGITUDE: -109.1993 UTM SURF EASTINGS: 654050 NORTHINGS: 44123	Surface
FIELD NAME: UNDESIGNATED (2 LEASE TYPE: 1 - Federal LEASE NUMBER: UTU-66761 SURFACE OWNER: 1 - Federal	
RECEIVED AND/OR REVIEWED: ✓ Plat ✓ Bond: Fed[1] Ind[] Sta[] Fee[] (No. LPM 4138223) Potash (Y/N) ✓ Oil Shale 190-5 (B) or 190-3 or 190-13 ✓ Water Permit (No. 43-8496) RDCC Review (Y/N) (Date:) ✓ Fee Surf Agreement (Y/N) Intent to Commingle (Y/N)	LOCATION AND SITING: R649-2-3. Unit: R649-3-2. General Siting: 460 From Qtr/Qtr & 920' Between Wells R649-3-3. Exception Drilling Unit Board Cause No: Eff Date: Siting: R649-3-11. Directional Drill
STIPULATIONS: 1- Edus O app 2- Spacer St	rorg P

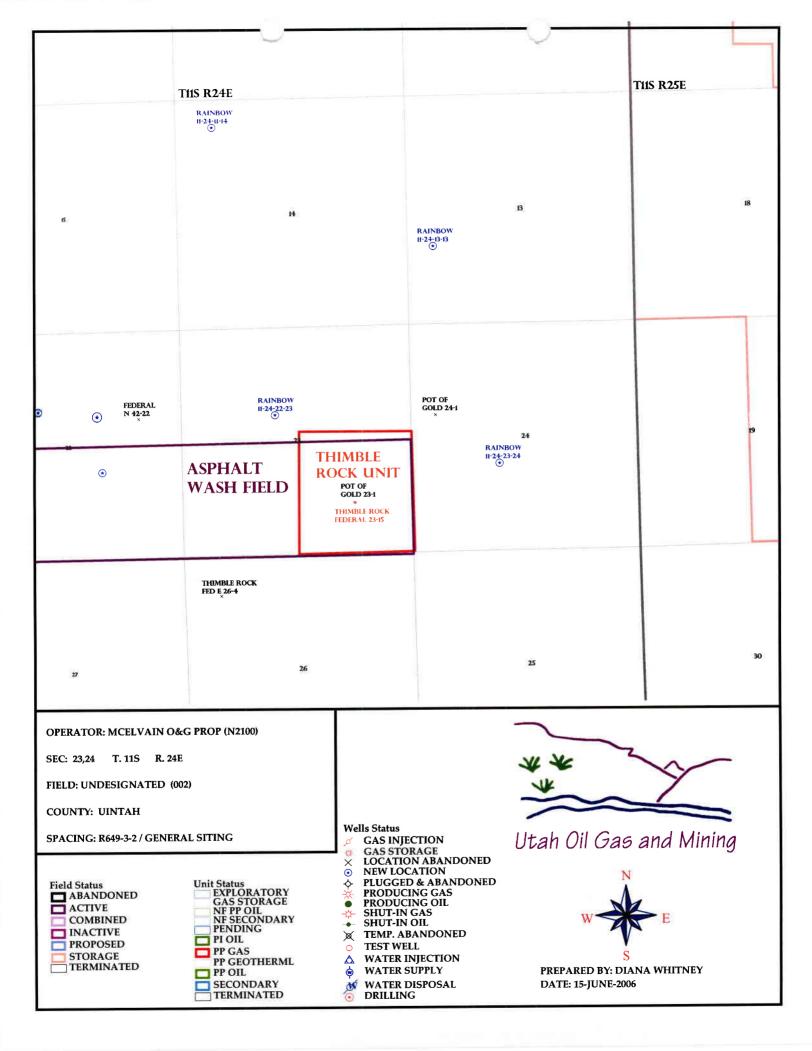



State of Utah

Department of Natural Resources

MICHAEL R. STYLER Executive Director

Division of Oil, Gas & Mining

JOHN R BAZA
Division Director

JON M. HUNTSMAN, JR. Governor

GARY R. HERBERT Lieutenant Governor

June 15, 2006

McElvain Oil & Gas Properties, Inc. 1050 17th St., Ste. 1800 Denver, CO 80265

Re:

Rainbow 11-24-22-23 Well, 2018' FNL, 2158' FWL, SE NW, Sec. 23,

T. 11 South, R. 24 East, Uintah County, Utah

Gentlemen:

Pursuant to the provisions and requirements of Utah Code Ann. § 40-6-1 et seq., Utah Administrative Code R649-3-1 et seq., and the attached Conditions of Approval, approval to drill the referenced well is granted.

This approval shall expire one year from the above date unless substantial and continuous operation is underway, or a request for extension is made prior to the expiration date. The API identification number assigned to this well is 43-047-38249.

Sincerely,

Stil H

Gil Hunt

Associate Director

pab Enclosures

cc:

Uintah County Assessor

Bureau of Land Management, Vernal District Office

Operator:	McElva	in Oil & Gas Properties, I	Inc.
Well Name & Number	Rainbo	w 11-24-22-23	
API Number:	43-047-	38249	
Lease:	UTU-60	6761	
Location: SE NW	Sec. 23	T. 11 South	R. <u>24 East</u>

Conditions of Approval

1. General

Compliance with the requirements of Utah Admin. R. 649-1 *et seq.*, the Oil and Gas Conservation General Rules, and the applicable terms and provisions of the approved Application for permit to drill.

2. Notification Requirements

Notify the Division within 24 hours of spudding the well.

• Contact Carol Daniels at (801) 538-5284.

Notify the Division prior to commencing operations to plug and abandon the well.

• Contact Dan Jarvis at (801) 538-5338

3. Reporting Requirements

All required reports, forms and submittals will be promptly filed with the Division, including but not limited to the Entity Action Form (Form 6), Report of Water Encountered During Drilling (Form 7), Weekly Progress Reports for drilling and completion operations, and Sundry Notices and Reports on Wells requesting approval of change of plans or other operational actions.

- 4. State approval of this well does not supersede the required federal approval, which must be obtained prior to drilling.
- 5. This proposed well is located in an area for which drilling units (well spacing patterns) have not been established through an order of the Board of Oil, Gas and Mining (the "Board"). In order to avoid the possibility of waste or injury to correlative rights, the operator is requested, once the well has been drilled, completed, and has produced, to analyze geological and engineering data generated therefrom, as well as any similar data from surrounding areas if available. As soon as is practicable after completion of its analysis, and if the analysis suggests an area larger than the quarter-quarter section upon which the well is located is being drained, the operator is requested to seek an appropriate order from the Board establishing drilling and spacing units in conformance with such analysis by filing a Request for Agency Action with the Board.

Division of Oil, Gas and Mining OPERATOR CHANGE WORKSHEET

ROUTING	
1. DJJ	
2 CDW	

X Change of Operator (Well Sold)

Designation of Agent/Operator

A Change of Operator (Wen Sold)	,						r	
Operator Name Change					Merger			
The operator of the well(s) listed below has cha	inged,	effectiv	re:			5/1/2007		
FROM: (Old Operator):				TO: (New O	perator):			
N2100-McElvain Oil & Gas Properties, Inc.				N2750-Enduri	-	s, LLC		
1050 17th St, Suite 1800				475 17	th Street, Su	ite 1500		
Denver, CO 80202				Denver	r, CO 80202			
Phone: 1-(303) 893-0933				Phone: 1-(303)	350-5102			
CA No).			Unit:				-
WELL(S)								
NAME	SEC	TWN	RNG	API NO	ENTITY	LEASE	WELL	WELL
					NO	TYPE	TYPE	STATUS
RAINBOW 11-24-13-13	13		240E	4304738247		Federal	GW	APD
RAINBOW 11-24-22-23	23		240E	4304738249		Federal	GW	APD_
RAINBOW 11-24-23-24	24	110S	240E	4304738254		Federal	GW	APD
OPERATOR CHANCES ROCHMEN	ar A ara							
OPERATOR CHANGES DOCUMEN	IAII	ION						
Enter date after each listed item is completed			41	EODMED		5/21/200	7	
1. (R649-8-10) Sundry or legal documentation								
2. (R649-8-10) Sundry or legal documentation						5/21/200		
3. The new company was checked on the Depar	rtment	of Cor	nmerce	e, Division of C	Corporations	Database o	on:	10/12/2006
4. Is the new operator registered in the State of	Utah:		YES	Business Num	ber:	5771233-01	161	
5a. (R649-9-2)Waste Management Plan has been	receive	ed on:		IN PLACE				
5b. Inspections of LA PA state/fee well sites com	plete c	on:		n/a	_			
5c. Reports current for Production/Disposition &	_			ok				
6. Federal and Indian Lease Wells: T			or the I	RIA has annr	– oved the m	erger nar	ne chang	e.
or operator change for all wells listed on Fed					BLM	not yet	BIA	n/a
of operator change for all wens fisted on red	Ciai oi	maian	icases (л.		_ not yet	<u> </u>	
DATA ENTRY:								
1. Changes entered in the Oil and Gas Databas	se on:			5/31/2007	_			
2. Changes have been entered on the Monthly	Operat	tor Cha	ange Sp	oread Sheet on:	:	5/31/200	<u>7_</u>	
3. Bond information entered in RBDMS on:			/	n/a				
4. Fee/State wells attached to bond in RBDMS	on:			<u>n/a</u>	_			
5. Injection Projects to new operator in RBDMS				<u>n/a</u>	_			
6. Receipt of Acceptance of Drilling Procedures	s for A	PD/Nev	w on:		5/21/2007	_		
FEDERAL WELL(S) BOND VERIFIC	~ A TI	ON:		 -				
1. Federal well(s) covered by Bond Number:	JAII	OIV.		UTB000173				
1. Federal well(s) covered by Bolid Number.				<u> </u>	-			
COMMENTS:								

STATE OF UTAH	FORM 9
DEPARTMENT OF NATURAL RESOURCES DIVISION OF OIL, GAS AND MINING	5. LEASE DESIGNATION AND SERIAL NUMBER: UTU-66761
SUNDRY NOTICES AND REPORTS ON WELLS	6. IF INDIAN, ALLOTTEE OR TRIBE NAME:
Do not use this form for proposals to drill new wells, significantly deepen existing wells below current bottom-hole depth, reenter plugged wells, or to drill horizontal laterals. Use APPLICATION FOR PERMIT TO DRILL form for such proposals.	7. UNIT or CA AGREEMENT NAME:
	8. WELL NAME and NUMBER:
1. TYPE OF WELL OIL WELL GAS WELL OTHER	Rainbow 11-24-22-23
2. NAME OF OPERATOR: Enduring Resources, LLC N3750	9. API NUMBER: 4304738249
Enduring Resources, LLC 3. ADDRESS OF OPERATOR: PHONE NUMBER:	10. FIELD AND POOL, OR WILDCAT:
475 17th Street, Suite 1500 CITY Denver STATE CO ZIP 80202 (303) 350-5114	undesignated
4. LOCATION OF WELL	
FOOTAGES AT SURFACE: 2,018' FNL - 2,158' FWL	соинту: Uintah
QTR/QTR, SECTION, TOWNSHIP, RANGE, MERIDIAN: SENW 23 11S 24E S	STATE: UTAH
11. CHECK APPROPRIATE BOXES TO INDICATE NATURE OF NOTICE, REPO	ORT, OR OTHER DATA
TYPE OF SUBMISSION TYPE OF ACTION	
DEEPEN	REPERFORATE CURRENT FORMATION
NOTICE OF INTENT (Submit in Duplicate) ALTER CASING FRACTURE TREAT	SIDETRACK TO REPAIR WELL
Approximate date work will start: CASING REPAIR NEW CONSTRUCTION	TEMPORARILY ABANDON
5/1/2007 CHANGE TO PREVIOUS PLANS OPERATOR CHANGE	TUBING REPAIR
CHANGE TUBING PLUG AND ABANDON	VENT OR FLARE
SUBSEQUENT REPORT CHANGE WELL NAME PLUG BACK	WATER DISPOSAL
(Submit Original Form Only) CHANGE WELL STATUS PRODUCTION (START/RESUME)	WATER SHUT-OFF
Date of work completion: COMMINGLE PRODUCING FORMATIONS RECLAMATION OF WELL SITE	OTHER:
CONVERT WELL TYPE RECOMPLETE - DIFFERENT FORMATION	
12. DESCRIBE PROPOSED OR COMPLETED OPERATIONS. Clearly show all pertinent details including dates, depths, volun	mes, etc.
Effective May 1, 2007	
Ellective May 1, 2007	
Change of Operator from: McElvain Oil & Gas Properties, Inc.	
2. Change of Operator to: Enduring Resources, LLC: BLM Statewide Oil & Gas Lease Bond no. UTB000 State of Utah, Division of Oil, Gas & Mining Surety	0173 Bond No. RL00008031
MCELVAIN OIL & GAS PROPERTIES, INC. N 3160 DATE: 5-12	
A A DATE: 5-12	7- 200 2
BY: James G. Hohenstein, Vice President - Land	. 2007
Alvin R. (Al) Arlian TIDE Landman - Regi	ulatory Specialist

5/16/2007

Alvin R. (Al) Arlian

Division of Oil, Gas and Mining Earlene Russell, Engineering Technician **RECEIVED**

MAY 2 1 2007

STATE OF UTAH DEPARTMENT OF NATURAL RESOURCES DIVISION OF OIL, GAS AND MINING

Request to Transfer Application or Permit to Drill

(This form should accompany a Sundry Notice, Form 9, requesting APD transfer)

Well name:	Rainbow 11-24-22-23
API number:	4204738249
Location:	Qtr-Qtr: SENW Section: 23 Township: 11S Range: 24E
Company that filed original application:	McElvain Oil & Gas Properties, Inc.
Date original permit was issued:	06/15/2006
Company that permit was issued to:	McElvain Oil & Gas Properties, Inc.

Check one	Desired Action:
	Transfer pending (unapproved) Application for Permit to Drill to new operator
	The undersigned as owner with legal rights to drill on the property, hereby verifies that the information as submitted in the pending Application for Permit to Drill, remains valid and does not require revision. The new owner of the application accepts and agrees to the information and procedures as stated in the application.
1	Transfer approved Application for Permit to Drill to new operator
	The undersigned as owner with legal rights to drill on the property as permitted, hereby verifies that the information as submitted in the previously approved application to drill, remains valid and does not require revision.

Following is a checklist of some items related to the application, which should be verified.	Yes	No
If located on private land, has the ownership changed?		1
If so, has the surface agreement been updated?		✓
Have any wells been drilled in the vicinity of the proposed well which would affect the spacing or siting requirements for this location?		✓
Have there been any unit or other agreements put in place that could affect the permitting or operation of this proposed well?		✓
Have there been any changes to the access route including ownership or right-of-way, which could affect the proposed location?		✓
Has the approved source of water for drilling changed?		✓
Have there been any physical changes to the surface location or access route which will require a change in plans from what was discussed at the onsite evaluation?		✓
Is bonding still in place, which covers this proposed well? Bond No. RLB0008031	✓	

Any desired or necessary changes to either a pending or approved Application for Permit to Drill that is being transferred, should be filed on a Sundry Notice, Form 9, or amended Application for Permit to Drill, Form 3, as appropriate, with necessary supporting information as required.

Name (please print) Alvin R. (Al) Arlian	Title Landman - Regulatory Specialist
Signature Signature	Date 05/16/2007
Representing (company name) Enduring Resources, LLC	

The person signing this form must have legal authority to represent the company or individual(s) to be listed as the new operation for Permit to Drill.

MAY 2 1 2007

RECEIVED VERNAL FIELD OFFICE

2006 JUN -8 PM 4: 06

Form 3160-3 (September 2001) DEPT. OF THE INTERIOR BUREAU OF LAND MGMT.

FORM APPROVED OMB No. 1004-0136 Expires January 31, 2004

UNITED STATES
DEPARTMENT OF THE INTERIOR
BUREAU OF LAND MANAGEMENT

DEPARTMENT OF THE INTERIOR BUREAU OF LAND MANAGEMENT			 Lease Serial No. UTU-66761 			
APPLICATION FOR PERMIT TO DRILL OR REENTER			6. If Indian, Allottee or Tribe Name N/A			
1a. Type of Work: DRILL REENTER			7. If Unit or CA Agreement, Name and No. N/A			
lb. Type of Well: Oil Well 🗹 Gas Well 🗖 Other	Single Zone 🗹 Multi	8. Lease Name and Well No. Rainbow 11-24-22-23				
2. Name of Operator McElvain Oil & Gas Properties, Inc.			9. API Well No. 43.047	382	149	
3a. Address 1050-17th Street, Ste. 1800 Denver, CO 80265	3b. Phone No. (include area code) (303) 893-0933	10. Field and Pool, or Exploratory Undetermined				
4. Location of Well (Report location clearly and in accordance with any State requirements.*)			11. Sec., T., R., M., or Blk. and Survey or Area			
At surface 2018' FNL & 2158' FWL (SENW) Sec. 23, T11S-R24E S.L.B. & M At proposed prod. zone same (vertical well)			Sec. 23, T11S-R24E SLB&M			
14. Distance in miles and direction from nearest town or post office* 20 miles South of Bonanza, Utah			12. County or Parish Uintah Cou		13. State Utah	
15. Distance from proposed* location to nearest 2,158 ft W. of lease/unit line property or lease line, ft. (Also to nearest drig. unit line, if any)	16. No. of Acres in lease 2,494.86	17. Spacing Unit dedicated to this well 40 Acres				
18. Distance from proposed location* to nearest well, drilling, completed, applied for, on this lease, ft.	19. Proposed Depth 20. BLM/BIA Bond No. on file 6,575 ft LPM 4138223 (Nation-Wide Boild			e Bond)		
21. Elevations (Show whether DF, KDB, RT, GL, etc.) 6,016.9' GL	22. Approximate date work will standard Cotober 2006	23. Estimated duration 30 Days Construction & Drilling				
	24. Attachments					
 The following, completed in accordance with the requirements of Onshor Well plat certified by a registered surveyor. A Drilling Plan. A Surface Use Plan (if the location is on National Forest System SUPO shall be filed with the appropriate Forest Service Office). 	4. Bond to cover to Item 20 above). Lands, the 5. Operator certific 6. Such other site	he operatio cation. specific inf	s form: ns unless covered by a formation and/or plans		·	
25. Signatura	authorized offic Name (Printed/Typed) Barbara Mai			Date	ne 2, 2006	
Title Engineer	,			1 53,	,	
Approved by (Signature)	Name (Printed/Typed)	Name (Printed/Typed)		Date 4-7-2007		
Title Assistant Field Manager Lands & Mineral Resources	Office VERNA	D OFFICE				
Application approval does not warrant or certify the the applicant holds le operations thereon.	egal or equitable title to those rights in	n the subject	lease which would enti	tle the appl	icant to conduct	

Conditions of approval, if any, are attached.

Title 18 U.S.C. Section 1001 and Title 43 U.S.C. Section 1212, make it a crime for any person knowingly and willfully to make to any department or agency of the United States any false, flotitious or fraudulent statements or representations as to any matter within its jurisdiction.

*(Instructions on reverse)

CONDITIONS OF APPROVAL ATTERSIVED JUN 1 1 2007



UNITED STATES DEPARTMENT OF THE INTERIOR **BUREAU OF LAND MANAGEMENT VERNAL FIELD OFFICE**

VERNAL, UT 84078

(435) 781-4400



CONDITIONS OF APPROVAL FOR APPLICATION FOR PERMIT TO DRILL

Company: McElvain Oil & Gas Properties, Inc. Location:

Lot 4, Sec. 23, T11S, R24E

Well No:

Rainbow 11-24-22-23

Lease No:

UTU-66761

API No:

43-047-38249

Agreement:

N/A

A COPY OF THESE CONDITIONS SHALL BE FURNISHED TO YOUR FIELD REPRESENTATIVE TO INSURE COMPLIANCE

All lease and/or unit operations are to be conducted in such a manner that full compliance is made with the applicable laws, regulations (43 CFR Part 3160), and this approved Application for Permit to Drill including Surface and Downhole Conditions of Approval. The operator is considered fully responsible for the actions of his subcontractors. A copy of the approved APD must be on location during construction, drilling, and completion operations. This permit is approved for a two (2) year period, or until lease expiration, whichever occurs first. An additional extension, up to two (2) years, may be applied for by sundry notice prior to expiration.

NOTIFICATION REQUIREMENTS

Location Construction (Notify Environmental Scientist)	-	Forty-Eight (48) hours prior to construction of location and access roads.
Location Completion (Notify Environmental Scientist)	-	Prior to moving on the drilling rig.
Spud Notice (Notify Petroleum Engineer)	-	Twenty-Four (24) hours prior to spudding the well.
Casing String & Cementing (Notify Supv. Petroleum Tech.)	-	Twenty-Four (24) hours prior to running casing and cementing all casing strings.
BOP & Related Equipment Tests (Notify Supv. Petroleum Tech.)	-	Twenty-Four (24) hours prior to initiating pressure tests.
First Production Notice (Notify Petroleum Engineer)	-	Within Five (5) business days after new well begins or production resumes after well has been off production for more than ninety (90) days.

Page 2 of 7 Well: Rainbow 11-24-22-23 6/5/2007

SURFACE USE PROGRAM CONDITIONS OF APPROVAL (COAs)

General Surface COAs

- If there is an active Gilsonite mining operation within 2 miles of the well location, operator shall notify the Gilsonite operator at least 48 hours prior to any blasting during construction.
- If paleontological materials are uncovered during construction, the operator is to immediately stop
 work and contact the Authorized Officer (AO). A report will be prepared by a BLM permitted
 paleontologist and submitted to the AO at the completion of surface disturbing activities.

Specific Surface COAs

• The interim seed mix for this location shall be:

Crested wheat grass Agropyron cristatum 4 lbs. /acre
Needle and Thread grass Stipa comata 4 lbs. /acre
Indian Rice grass Stipa hymenoides 4 lbs. /acre

All pounds are in pure live seed.

- Reseeding may be required if first seeding is not successful.
- The topsoil from the reserve pit shall be stripped and piled separately near the reserve pit.
 When the reserve pit is closed, it shall be recontoured and the topsoil respread, and the area shall be seeded in the same manner as the location topsoil.
- Once the location is plugged and abandoned, it shall be recontoured to natural contours, topsoil
 respread where appropriate, and the entire location seeded with the recommended seed mix.
 Seeding shall take place by broadcasting the seed and walking it into the soil with a dozer
 immediately after the dirt work is completed.
- The well will be spudded within five years of the existing or supplemented NEPA documentation.
- The requested color for all permanent structures is Olive Black.
- All pits will be lined with felt.
- The lessee/operator is given notice the area has critical soils. It is requested that the operator not initiate surface disturbing activities or wet or muddy conditions.
- Keep excess material out of drainages.
- In order to minimize impacts during crucial winter deer and elk habitat, surface disturbing
 activities will not be allowed during November 1 and April 30. This limitation does not apply to
 maintenance and operation of producing wells. This stipulation may be waived by the
 authorized officer if either the resource values changed or the lessee/operator demonstrates
 that adverse impacts can be mitigated.
- Within 90 calendar days of the approval date for this Application for Permit to Drill (APD), the
 operator/lessee shall submit to the Authorized Officer (AO), on Sundry Notice Form 3160-5, an
 Interim Surface Reclamation Plan for surface disturbance on well pads, access roads, and

Page 3 of 7 Well: Rainbow 11-24-22-23 6/5/2007

pipelines. At a minimum, this will include the reshaping of the pad to the original contour to the extent possible; the respreading of the top soil up to the rig anchor points; and, the area reseeded using appropriate reclamation methods. The AO will provide written approval or concurrence within 30 calendar days of receipt.

- The best method to avoid entrainment is to pump from an off-channel location-one that does not connect to the river during high spring flows. An infiltration gallery constructed in a BLM and Service approved location is best.
- If the pump head is located in the river channel where larval fish are known to occur, the following measures apply:
 - (a) do not situate the pump in a low-flow or no-flow area as these habitats tend to concentrate larval fishes;
 - (b) limit the amount of pumping, to the greatest extent possible, during that period of the year when larval fish may be present (see above); and
 - (c) limit the amount of pumping, to the greatest extent possible, during the pre-dawn hours as larval drift studies indicate that this is a period of greatest daily activity.
- Screen all pump intakes with ¼" mesh material.
- Report any fish impinged on the intake screen to the Service (801.975.3330) and the Utah Division of Wildlife Resources:

Northeastern Region 152 East 100 North Vernal, UT 84078 Phone: (435) 781-9453

Page 4 of 7 Well: Rainbow 11-24-22-23 6/5/2007

DOWNHOLE CONDITIONS OF APPROVAL

SITE SPECIFIC DOWNHOLE CONDITIONS OF APPROVAL

- A surface casing shoe integrity test shall be performed.
- Production casing cement top shall be at a minimum of 200' above the surface casing shoe.

All provisions outlined in Onshore Oil & Gas Order #2 Drilling Operations shall be strictly adhered to. The following items are emphasized:

DRILLING/COMPLETION/PRODUCING OPERATING STANDARDS

- The spud date and time shall be reported orally to Vernal Field Office within 24 hours of spudding.
- Notify Vernal Field Office Supervisory Petroleum Engineering Technician at least 24 hours in advance of casing cementing operations and BOPE & casing pressure tests.
- Blowout prevention equipment (BOPE) shall remain in use until the well is completed or abandoned. Closing unit controls shall remain unobstructed and readily accessible at all times. Choke manifolds shall be located outside of the rig substructure.
- All BOPE components shall be inspected daily and those inspections shall be recorded in the
 daily drilling report. Components shall be operated and tested as required by Onshore Oil &
 Gas Order No. 2 to insure good mechanical working order. All BOPE pressure tests shall be
 performed by a test pump with a chart recorder and <u>NOT</u> by the rig pumps. Test shall be
 reported in the driller's log.
- BOP drills shall be initially conducted by each drilling crew within 24 hours of drilling out from under the surface casing and weekly thereafter as specified in Onshore Oil & Gas Order No. 2.
- Casing pressure tests are required before drilling out from under all casing strings set and cemented in place.
- No aggressive/fresh hard-banded drill pipe shall be used within casing.
- Cement baskets shall not be run on surface casing.
- The operator must report all shows of water or water-bearing sands to the BLM. If flowing water
 is encountered it must be sampled, analyzed, and a copy of the analyses submitted to the BLM
 Vernal Field Office.
- The operator must report encounters of all non oil & gas mineral resources (such as Gilsonite, tar sands, oil shale, trona, etc.) to the Vernal Field Office, in writing, within 5 working days of each encounter. Each report shall include the well name/number, well location, date and depth (from KB or GL) of encounter, vertical footage of the encounter and, the name of the person making the report (along with a telephone number) should the BLM need to obtain additional information.

Page 5 of 7 Well: Rainbow 11-24-22-23 6/5/2007

- A complete set of angular deviation and directional surveys of a directional well will be submitted to the Vernal BLM office engineer within 30 days of the completion of the well.
- Chronologic drilling progress reports shall be filed directly with the BLM, Vernal Field Office on a
 weekly basis in sundry, letter format or e-mail to the Petroleum Engineers until the well is
 completed.
- A cement bond log (CBL) will be run from the production casing shoe to the top of cement and shall be utilized to determine the bond quality for the production casing. Submit a field copy of the CBL to this office.
- Please submit an electronic copy of all other logs run on this well in LAS format to UT_VN_Welllogs@BLM.gov. This submission will supersede the requirement for submittal of paper logs to the BLM.
- There shall be no deviation from the proposed drilling, completion, and/or workover program as approved. Safe drilling and operating practices must be observed. Any changes in operation must have prior approval from the BLM Vernal Field Office.

Page 6 of 7 Well: Rainbow 11-24-22-23 6/5/2007

OPERATING REQUIREMENT REMINDERS:

 All wells, whether drilling, producing, suspended, or abandoned, shall be identified in accordance with 43 CFR 3162.6. There shall be a sign or marker with the name of the operator, lease serial number, well number, and surveyed description of the well.

- In accordance with 43 CFR 3162.4-3, this well shall be reported on the "Monthly Report of Operations" (Oil and Gas Operations Report ((OGOR)) starting with the month in which operations commence and continue each month until the well is physically plugged and abandoned. This report shall be filed in duplicate, directly with the Minerals Management Service, P.O. Box 17110, Denver, Colorado 80217-0110, or call 1-800-525-7922 (303) 231-3650 for reporting information.
- Should the well be successfully completed for production, the BLM Vernal Field office must be
 notified when it is placed in a producing status. Such notification will be by written communication
 and must be received in this office by not later than the fifth business day following the date on which
 the well is placed on production. The notification shall provide, as a minimum, the following
 informational items:
 - Operator name, address, and telephone number.
 - Well name and number.
 - Well location (¼¼, Sec., Twn, Rng, and P.M.).
 - Date well was placed in a producing status (date of first production for which royalty will be paid).
 - The nature of the well's production, (i.e., crude oil, or crude oil and casing head gas, or natural gas and entrained liquid hydrocarbons).
 - o The Federal or Indian lease prefix and number on which the well is located; otherwise the non-Federal or non-Indian land category, i.e., State or private.
 - Unit agreement and/or participating area name and number, if applicable.
 - Communitization agreement number, if applicable.
- Any venting or flaring of gas shall be done in accordance with Notice to Lessees (NTL) 4A and needs prior approval from the BLM Vernal Field Office.
- All undesirable events (fires, accidents, blowouts, spills, discharges) as specified in NTL 3A will be reported to the BLM, Vernal Field Office. Major events, as defined in NTL3A, shall be reported verbally within 24 hours, followed by a written report within 15 days. "Other than Major Events" will be reported in writing within 15 days. "Minor Events" will be reported on the Monthly Report of Operations and Production.
- Whether the well is completed as a dry hole or as a producer, "Well Completion and Recompletion Report and Log" (BLM Form 3160-4) shall be submitted not later than 30 days after completion of the well or after completion of operations being performed, in accordance with 43 CFR 3162.4-1. Two copies of all logs run, core descriptions, and all other surveys or data obtained and compiled during the drilling, workover, and/or completion operations, shall be filed on BLM Form 3160-4. Submit with the well completion report a geologic report including, at a minimum, formation tops, and a summary and conclusions. Also include deviation surveys, sample descriptions, strip logs, core data, drill stem test data, and results of production tests if performed. Samples (cuttings, fluid,

Page 7 of 7 Well: Rainbow 11-24-22-23 6/5/2007

and/or gas) shall be submitted only when requested by the BLM, Vernal Field Office.

 All off-lease storage, off-lease measurement, or commingling on-lease or off-lease, shall have prior written approval from the BLM Vernal Field Office.

- Oil and gas meters shall be calibrated in place prior to any deliveries. The BLM Vernal Field Office Petroleum Engineers will be provided with a date and time for the initial meter calibration and all future meter proving schedules. A copy of the meter calibration reports shall be submitted to the BLM Vernal Field Office. All measurement facilities will conform to the API standards for liquid hydrocarbons and the AGA standards for natural gas measurement. All measurement points shall be identified as the point of sale or allocation for royalty purposes.
- A schematic facilities diagram as required by Onshore Oil & Gas Order No. 3 shall be submitted to
 the BLM Vernal Field Office within 30 days of installation or first production, whichever occurs first.
 All site security regulations as specified in Onshore Oil & Gas Order No. 3 shall be adhered to. All
 product lines entering and leaving hydrocarbon storage tanks will be effectively sealed in
 accordance with Onshore Oil & Gas Order No. 3.
- Any additional construction, reconstruction, or alterations of facilities, including roads, gathering
 lines, batteries, etc., which will result in the disturbance of new ground, shall require the filing of a
 suitable plan and need prior approval of the BLM Vernal Field Office. Emergency approval may be
 obtained orally, but such approval does not waive the written report requirement.
- No location shall be constructed or moved, no well shall be plugged, and no drilling or workover
 equipment shall be removed from a well to be placed in a suspended status without prior approval of
 the BLM Vernal Field Office. If operations are to be suspended for more than 30 days, prior
 approval of the BLM Vernal Field Office shall be obtained and notification given before resumption of
 operations.
- Pursuant to Onshore Oil & Gas Order No. 7, this is authorization for pit disposal of water produced from this well for a period of 90 days from the date of initial production. A permanent disposal method must be approved by this office and in operation prior to the end of this 90-day period. In order to meet this deadline, an application for the proposed permanent disposal method shall be submitted along with any necessary water analyses, as soon as possible, but no later than 45 days after the date of first production. Any method of disposal which has not been approved prior to the end of the authorized 90-day period will be considered as an Incident of Noncompliance and will be grounds for issuing a shut-in order until an acceptable manner for disposing of said water is provided and approved by this office.
- Unless the plugging is to take place immediately upon receipt of oral approval, the Field Office Petroleum Engineers must be notified at least 24 hours in advance of the plugging of the well, in order that a representative may witness plugging operations. If a well is suspended or abandoned, all pits must be fenced immediately until they are backfilled. The "Subsequent Report of Abandonment" (Form BLM 3160-5) must be submitted within 30 days after the actual plugging of the well bore, showing location of plugs, amount of cement in each, and amount of casing left in hole, and the current status of the surface restoration.

STATE OF UTAH

DEPARTMENT OF NATURAL RESOURCES	E LEACE DESIGNATION AND SERVAL AND MEDER.
DIVISION OF OIL, GAS AND MINING	5. LEASE DESIGNATION AND SERIAL NUMBER: UTU-66761
SUNDRY NOTICES AND REPORTS ON WELLS	6. IF INDIAN, ALLOTTEE OR TRIBE NAME:
Do not use this form for proposals to drill new wells, significantly deepen existing wells below current bottom-hole depth, reenter plugged wells, or to drill horizontal laterals. Use APPLICATION FOR PERMIT TO DRILL form for such proposals.	
1. TYPE OF WELL OIL WELL GAS WELL OTHER	8. WELL NAME and NUMBER: Rainbow 11-24-22-23
2. NAME OF OPERATOR:	9. API NUMBER:
Enduring Resources, LLC 3. ADDRESS OF OPERATOR: PHONE NUMBER:	4304738249 10. FIELD AND POOL, OR WILDCAT:
475 17th Street, Suite 1500 CITY Denver STATE CO ZIP 80202 (303) 350-5719	Undesignated
4. LOCATION OF WELL FOOTAGES AT SURFACE: 2018' FNL - 2158' FWL	соинту: Uintah
QTR/QTR, SECTION, TOWNSHIP, RANGE, MERIDIAN: SENW 23 11S 24E S	STATE: UTAH
11. CHECK APPROPRIATE BOXES TO INDICATE NATURE OF NOTICE, REPO	ORT, OR OTHER DATA
TYPE OF SUBMISSION TYPE OF ACTION	
NOTICE OF INTENT (Submit in Duplicate) ACIDIZE DEEPEN FRACTURE TREAT	REPERFORATE CURRENT FORMATION SIDETRACK TO REPAIR WELL
(Submit in Duplicate)	TEMPORARILY ABANDON
CHANGE TO PREVIOUS PLANS OPERATOR CHANGE	TUBING REPAIR
CHANGE TUBING PLUG AND ABANDON	VENT OR FLARE
SUBSEQUENT REPORT CHANGE WELL NAME PLUG BACK	WATER DISPOSAL
(Submit Original Form Only) CHANGE WELL STATUS PRODUCTION (START/RESUME)	WATER SHUT-OFF
Date of work completion: COMMINGLE PRODUCING FORMATIONS RECLAMATION OF WELL SITE	OTHER: Request for APD
CONVERT WELL TYPE RECOMPLETE - DIFFERENT FORMATION	Extension
DESCRIBE PROPOSED OR COMPLETED OPERATIONS. Clearly show all pertinent details including dates, depths, volu-	
FROM: 6/15/2007	
TO: 6/15/2008 Approved by the Utah Division of	
Oil, Gas and Mining	RECEIVED
	JUN 1 5 2007
By: No. (1)	DIV. OF OIL, GAS & MINING
\mathcal{M}	SENT TO OFFICE
NAME (PLEASE PRINT) Evette Bissett TITLE Regulatory Affa	irs Assistant RM
SIGNATURE GUELLO Bisself DATE 6/12/2007	

(This space for State use only)

Application for Permit to Drill Request for Permit Extension Validation (this form should accompany the Sundry Notice requesting permit extension)

API: 4304738249	
Well Name: Rainbow 11-24-22-23 Location: 2018' FNL - 2158' FWL, SENW, Sec 23, T11S-R24E	
Company Permit Issued to: McElvain Oil and Gas Properties, Inc.	
Date Original Permit Issued: 6/15/2006	
The undersigned as owner with legal rights to drill on the property as permitted above, hereby verifies that the information as submitted in the previously approved application to drill, remains valid and does not require revision.	
Following is a checklist of some items related to the application, which should be verified.	<u>e</u>
If located on private land, has the ownership changed, if so, has the surface agreement been updated? Yes□No□	
Have any wells been drilled in the vicinity of the proposed well which would affe the spacing or siting requirements for this location? Yes□No☑	ct
Has there been any unit or other agreements put in place that could affect the permitting or operation of this proposed well? Yes□No☑	
Have there been any changes to the access route including ownership, or right-of-way, which could affect the proposed location? Yes□No ☑	•
Has the approved source of water for drilling changed? Yes□No☑	
Have there been any physical changes to the surface location or access route which will require a change in plans from what was discussed at the onsite evaluation? Yes□No☑	
Is bonding still in place, which covers this proposed well? Yes ☑No□	
Guetto Bissel 6/12/2007	
Signature Date	
Title: Regulatory Affairs Assistant	
Representing: Enduring Resources, LLC	



UT08300

United States Department of the Interior

BUREAU OF LAND MANAGEMENT

Vernal Field Office 170 South 500 East Vernal, UT 84078

(435) 781-4400 Fax: (435) 781-4410 http://www.blm.gov/ut/st/en/fo/vernal/html

http://ww in reply refer to: 3160



May 2, 2008

Alvin R. (AI) Arlian Enduring Resources, LLC 475 17th Street, Suite 1500 Denver, CO 80202

Re:

Well No. Rainbow 11-24-22-23

SENW Lot 4, Sec. 23, T11S, R24E

Uintah County, Utah Lease No. UTU-66761

Dear Mr. Arlian:

This correspondence is in regard to the self-certification statement submitted requesting a change of operator for the referenced well. After a review by this office, the change of operator request is approved. Effective immediately, Enduring Resources, LLC is responsible for all operations performed on the above referenced well. All liability will now fall under your bond, BLM Bond No. UTB000173, for all operations conducted on the referenced well on the leased land.

If you have any other questions regarding this matter, please contact Cindy Severson of this office at (435) 781-4455.

Sincerely,

Matt Baker

Petroleum Engineer

Enclosure

cc:

UDOGM

Rosewood Resources Inc

Form 3160-5 (April 2004)

UNITED STATES DEPARTMENT OF THE INTERIOR

FORM APPROVED OMB No. 1004-0137 Expires: March 31, 2007

BUREAU OF LAND MANAGEMENT	5. Lease Serial No.
SUNDRY NOTICES AND REPORTS ON WELLS	UTU-66761
Do not use this form for proposals to drill or to re-enter ar abandoned well. Use Form 3160-3 (APD) for such proposals.	6. If Indian, Allottee or Tribe Name
SUBMIT IN TRIPLICATE- Other instructions on reverse side	e. 7. If Unit or CA/Agreement, Name and/or No.
1. Type of Well	8. Well Name and No.
2. Name of Operator Enduring Resources, LLC	Rainbow 11-24-22-23 9. API Well No.
Sa. Address 3b. Phone No. (include area code	
475-17th Street, Suite 1500, Denver, CO 80202 303-350-5114	10. Field and Pool, or Exploratory Area
 Location of Well (Footage, Sec., T., R., M., or Survey Description) 2,018' FNL - 2,158' FWL SENW Sec 23, T11S-R24E 	undesignated 11. County or Parish, State
	Uintah, Utah
12. CHECK APPROPRIATE BOX(ES) TO INDICATE NATURE OF N	OTICE, REPORT, OR OTHER DATA
TYPE OF SUBMISSION TYPE OF A	CTION
Notice of Intent Alter Casing Fracture Treat Rec	oduction (Start/Resume) Water Shut-Off clamation Well Integrity
Change Plans Plug and Abandon Ter	complete Other Change of Operator mporarily Abandon
Final Abandonment Notice	ater Disposal
1. Change of Operator from: McElvain Oil & Gas Properties, Inc. 2. Change of Operator to: Enduring Resources, LLC: BLM Statewide Oil & Gas Lease Bond no. UTBO State of Utah, Division of Oil, Gas & Mining Sure MCELVAIN OIL & GAS PROPERTIES D.C. BY: James G. Hohenstein, Vice President - Land	1 1 1
4. I hereby certify that the foregoing is true and correct	DIV. OF SIE
Name (Printed/Typed)	Regulatory Specialist
Signature Date	05/16/2007
THIS SPACE FOR FEDERAL OR STATE	OFFICE USE
Approved by Patrole Conditions of approval, if any, are attached. Approval of this notice does not warrant or	eum Enginee MAY 0 2 2008

Title 18 U.S.C. Section 1001 and Title 43 U.S.C. Section 1212, make it a crime for any person knowingly and willfully to make to any department or agency of the United States any false, fictitious or fraudulent statements or representations as to any matter within its jurisdiction.

(Instructions on page 2)



SELF-CERTIFICATION STATEMENT

The following self-certification statement is provided per federal requirements dated June 15, 1988.

Please be advised that Enduring Resources, LLC is considered to be the operator of the following well.

Rainbow 11-24-22-23

SENW Sec. 23-11S-24E

2,018' FNL - 2,158' FWL

Lease Serial No.: UTU-66761

Uintah County, Utah

Enduring Resources, LLC is responsible under the terms and conditions of the lease for the operations conducted upon leased lands. Bond coverage is provided by UTB000173.

Alvin R. Arlian

5/14/2007

Date

Landman - Regulatory Specialist

Enduring Resources, LLC 475 17th Street, Suite 1500

Denver, CO 80202 (303) 350-5114

FORM 9 STATE OF UTAH DEPARTMENT OF NATURAL RESOURCES 5. LEASE DESIGNATION AND SERIAL NUMBER: DIVISION OF OIL, GAS AND MINING UTU-66761 6. IF INDIAN, ALLOTTEE OR TRIBE NAME: SUNDRY NOTICES AND REPORTS ON WELLS 7. UNIT or CA AGREEMENT NAME: Do not use this form for proposals to drill new wells, significantly deepen existing wells below current bottom-hole depth, reenter plugged wells, or to drill horizontal laterals. Use APPLICATION FOR PERMIT TO DRILL form for such proposals. n/a 8. WELL NAME and NUMBER: 1. TYPE OF WELL GAS WELL 🗸 OIL WELL OTHER Rainbow 11-24-22-23 9. API NUMBER: 2. NAME OF OPERATOR: 4304738249 Enduring Resources, LLC 3. ADDRESS OF OPERATOR: PHONE NUMBER: 10. FIELD AND POOL, OR WILDCAT: OTY Denver STATE CO (303) 350-5719 Undesignated 475 17th Street, Suite 1500 715 80202 4. LOCATION OF WELL FOOTAGES AT SURFACE: 2018' FNL - 2158' FWL COUNTY: Uintah QTR/QTR, SECTION, TOWNSHIP, RANGE, MERIDIAN: SENW 23 11S 24E STATE: **UTAH** CHECK APPROPRIATE BOXES TO INDICATE NATURE OF NOTICE, REPORT, OR OTHER DATA 11. TYPE OF ACTION TYPE OF SUBMISSION REPERFORATE CURRENT FORMATION DEEPEN ACIDIZE V NOTICE OF INTENT (Submit in Duplicate) ALTER CASING FRACTURE TREAT SIDETRACK TO REPAIR WELL Approximate date work will start: CASING REPAIR NEW CONSTRUCTION TEMPORARILY ABANDON TUBING REPAIR OPERATOR CHANGE CHANGE TO PREVIOUS PLANS CHANGE TUBING PLUG AND ABANDON VENT OR FLARE SUBSEQUENT REPORT WATER DISPOSAL CHANGE WELL NAME PLUG BACK (Submit Original Form Only) WATER SHUT-OFF CHANGE WELL STATUS PRODUCTION (START/RESUME) Date of work completion: OTHER: Request for APD COMMINGLE PRODUCING FORMATIONS RECLAMATION OF WELL SITE Extension **RECOMPLETE - DIFFERENT FORMATION** CONVERT WELL TYPE 12. DESCRIBE PROPOSED OR COMPLETED OPERATIONS. Clearly show all pertinent details including dates, depths, volumes, etc. Enduring Resources, LLC respectfully request an extension to the expiration date of this Application for Permit to Drill FROM: 6/18/2008 6/18/2009 TO: Approved by the Utah Division of Oil, Gas and Mining COPY SENT TO OPERATOR Date: 6:19:2008 Initials: Landman Alvin R. (Al) Arlian NAME (PLEASE PRINT)

(This space for State use only)

SIGNATURE

RECEIVED

JUN 18 2008

6/1/2008



Application for Permit to Drill Request for Permit Extension Validation

(this form should accompany the Sundry Notice requesting permit extension)

API: 4304738249 Well Name: Rainbow 11-24-22-23 Location: 2018' FNL - 2158' FWL, SENW, Sec 23, T118- Company Permit Issued to: McElvain Oil and Gas Pro Date Original Permit Issued: 6/15/2006	
The undersigned as owner with legal rights to drill on above, hereby verifies that the information as submitted approved application to drill, remains valid and does re	ed in the previously
Following is a checklist of some items related to the a verified.	pplication, which should be
If located on private land, has the ownership changed agreement been updated? Yes□No□	, if so, has the surface
Have any wells been drilled in the vicinity of the proporthe spacing or siting requirements for this location? Yes	
Has there been any unit or other agreements put in ple permitting or operation of this proposed well? Yes□N	
Have there been any changes to the access route incof-way, which could affect the proposed location? Yes	, ,
Has the approved source of water for drilling changed	l? Yes□No⊠
Have there been any physical changes to the surface which will require a change in plans from what was die evaluation? Yes□No☑	
Is bonding still in place, which covers this proposed w	ell? Yes☑No□
	6/1/2008
Signature	Date
Title: Landman	
Representing: Enduring Resources, LLC	
	DECEIVED

JUN 18 2008

SUNDRY NOTICES AND REPORTS ON WELLS Do not use this form for proposals to drill new wells, significantly deepen existing wells below current to DRILL form for such proposals. In drill new wells, significantly deepen existing wells below current to DRILL form for such proposals. 2 NAME OF OPERATOR: Enduring Resources, LLC AND ADDRESS OF DEFEATOR: AND ADDRESS OF DEFEATOR: UNITARI UNITARI UNITARI UNITARI UNITARI UNITARI CHECK APPROPRIATE BOXES TO INDICATE NATURE OF NOTICE, REPORT, OR OTHER DATA TYPE OF SUBMISSION TYPE OF ACTION ACIDIZE ACI	STATE OF UTAH					FORM 9
Do not use this form for proposals to drill new wells, significantly deepen existing wells below current to bottom-hole depth, reenter plugged wells, or to drill horizontal laterals. Use APPLICATION FOR PRINTI TO BUILL from for supposals to drill new wells, significantly deepen existing wells below current to bottom-hole depth, reenter plugged wells, or to drill horizontal laterals. Use APPLICATION FOR PRINTI TO BUILL from for supposals. 1. 17YE OF WELL 2. NAME OF OPERATOR: 3. NAME OF OPERATOR OPERATOR OPERATOR OF OPERATOR OPERATOR OF OPERATOR OF OPERATOR OF OPERATOR OPERATOR OF OPERATO	DEPARTMENT OF NATURAL RESOURCES DIVISION OF OIL, GAS, AND MINING			3		
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Cas Well I NAME OF OPERATOR: I NAME OPERATOR:	bottom-hole depth, reenter plu	igged wells, or to drill horizontal laterals.			7.UNIT	or CA AGREEMENT NAME:
ADDRESS OF OPERATOR: 4. JOACHTON OF WELL 5. JOHN SECTION, TOWNSHIP, RANGE, MERIDIAN: QUE/QIT: SENW Section: 23 Township: 11.05 Range: 24.06 Meridian: S 11. CHECK APPROPRIATE BOXES TO INDICATE NATURE OF NOTICE, REPORT, OR OTHER DATA TYPE OF SUBMISSION TYPE OF SUBMISSION ACIDIZE APPROPRIATE BOXES TO INDICATE NATURE OF NOTICE, REPORT, OR OTHER DATA TYPE OF SUBMISSION ACIDIZE APPROPRIATE BOXES TO INDICATE NATURE OF NOTICE, REPORT, OR OTHER DATA TYPE OF SUBMISSION ACIDIZE APPROPRIATE BOXES TO INDICATE NATURE OF NOTICE, REPORT, OR OTHER DATA TYPE OF SUBMISSION ACIDIZE APPROPRIATE APPROPRIATE APPROPRIATE APPROPRIATE ORIGINATE WELL STATUS CHANGE W						
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TYPE OF SUBMISSION ACIDIZE	FOOTAGES AT SURFACE: 2018 FNL 2158 FWL	D DANCE MEDIDAN				
TYPE OF SUBMISSION TYPE OF ACTION ACIDIZE			ı: S			
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MONTE OF INTENT Approximated desired work will start: 6/18/2009 CHANGE WELL STATUS	TYPE OF SUBMISSION			TYPE OF ACTION		
Approved by the Utah Division of Oil, Gas and Mining Approved by the Utah Division of Oil, Gas and Mining Approved by the Utah Division of Oil, Gas and Mining Approved by the Utah Division of Oil, Gas and Mining Date: June 23, 2009 By: Date: Da		☐ ACIDIZE		ALTER CASING		CASING REPAIR
CHANGE WELL STATUS	Approximate date work will start:	CHANGE TO PREVIOUS PLANS		CHANGE TUBING		CHANGE WELL NAME
Detect Work Competion: OPERATOR CHANGE PLUG AND ABANDON PLUG BACK PRODUCTION START OR RESUME RECLAMATION OF WELL SITE RECOMPLETE DIFFERENT FORMATION Date of Spud: PRODUCTION START OR RESUME RECLAMATION OF WELL SITE RECOMPLETE DIFFERENT FORMATION Date of Spud: PRODUCTION START OR RESUME RECLAMATION OF WELL SITE RECOMPLETE DIFFERENT FORMATION Date of Spud: PROPORTY ABANDON PLUG BACK RECLAMATION OF WELL SITE RECOMPLETE DIFFERENT FORMATION DRILLING REPORT WATER SHUTOFF SI TA STATUS EXTENSION APD EXTENSION DRILLING REPORT WATER SHUTOFF SI TA STATUS EXTENSION OTHER: 12. DESCRIBE PROPOSED OR COMPLETED OPERATIONS. Clearly show all pertinent details including dates, depths, volumes, etc. Request extend to APD expiration date. Approved by the Utah Division of Oil, Gas and Mining Date: June 23, 2009 By: June 24, 2009 By: June 25, 2009 By: June 26, 2009 By: June 27, 2009 By: June 28, 2009	6/18/2009	CHANGE WELL STATUS		COMMINGLE PRODUCING FORMATIONS		CONVERT WELL TYPE
OPERATOR CHANGE PLUG AND ABANDON PLUG BACK PRODUCTION START OR RESUME RECLAMATION OF WELL SITE RECOMPLETE DIFFERENT FORMATION SIDETRACK TO REPAIR WELL TEMPORARY ABANDON PLUG BACK WATER DISPOSAL WATER DISPOSAL WATER SHUTOFF SI TA STATUS EXTENSION APD EXTENSION OTHER: O		DEEPEN	☐ F	FRACTURE TREAT		NEW CONSTRUCTION
SPUD REPORT Date of Spud: REPERFORATE CURRENT FORMATION SIDETRACK TO REPAIR WELL TEMPORARY ABANDON TUBING REPAIR VENT OR FLARE WATER DISPOSAL WATER SHUTOFF SI TA STATUS EXTENSION APD EXTENSION WILDCAT WELL DETERMINATION OTHER 12. DESCRIBE PROPOSED OR COMPLETED OPERATIONS. Clearly show all pertinent details including dates, depths, volumes, etc. Request extend to APD expiration date. Approved by the Utah Division of Oil, Gas and Mining Date: June 23, 2009 By: NAME (PLEASE PRINT) PHONE NUMBER TITLE	Date of Work Completion:	OPERATOR CHANGE	☐ F	PLUG AND ABANDON		PLUG BACK
Date of Spud: □ Datuling Report Report Date: □ DRILLING REPORT Report Date: □ DESCRIBE PROPOSED OR COMPLETED OPERATIONS. Clearly show all pertinent details including dates, depths, volumes, etc. Request extend to APD expiration date. Approved by the Utah Division of Oil, Gas and Mining Date: June 23, 2009 By: NAME (PLEASE PRINT) PHONE NUMBER VENT OR FLARE WATER DISPOSAL WATER DISP	_	PRODUCTION START OR RESUME	_ F	RECLAMATION OF WELL SITE		RECOMPLETE DIFFERENT FORMATION
DRILLING REPORT Report Date: Water shutoff WILDCAT WELL DETERMINATION OTHER USIDESCRIBE PROPOSED OR COMPLETED OPERATIONS. Clearly show all pertinent details including dates, depths, volumes, etc. Request extend to APD expiration date. Approved by the Utah Division of Oil, Gas and Mining Date: June 23, 2009 By: NAME (PLEASE PRINT) PHONE NUMBER TITLE		REPERFORATE CURRENT FORMATION		SIDETRACK TO REPAIR WELL		TEMPORARY ABANDON
NAME (PLEASE PRINT) WILDCAT WELL DETERMINATION OTHER OTHER: WILDCAT WELL DETERMINATION OTHER OTHER: OTHER:		TUBING REPAIR		VENT OR FLARE		WATER DISPOSAL
□ WILDCAT WELL DETERMINATION □ OTHER OTHER: 12. DESCRIBE PROPOSED OR COMPLETED OPERATIONS. Clearly show all pertinent details including dates, depths, volumes, etc. Request extend to APD expiration date. Approved by the Utah Division of Oil, Gas and Mining Date: June 23, 2009 By: NAME (PLEASE PRINT) PHONE NUMBER TITLE		☐ WATER SHUTOFF		SI TA STATUS EXTENSION	1	APD EXTENSION
Request extend to APD expiration date. Approved by the Utah Division of Oil, Gas and Mining Date: June 23, 2009 By:	Report Date:	☐ WILDCAT WELL DETERMINATION		OTHER	отн	ER:
Approved by the Utah Division of Oil, Gas and Mining Date: June 23, 2009 By:					volumes,	etc.
Utah Division of Oil, Gas and Mining Date: June 23, 2009 By: State of Oil, Gas and Mining By: State of Oil, Gas and Mining By: State of Oil, Gas and Mining Date: June 23, 2009 By: State of Oil, Gas and Mining Date: June 23, 2009 By: State of Oil, Gas and Mining Date: June 23, 2009 By: State of Oil, Gas and Mining Date: June 23, 2009 By: State of Oil, Gas and Mining Date: June 23, 2009 By: State of Oil, Gas and Mining Date: June 23, 2009 By: State of Oil, Gas and Mining Date: June 23, 2009 By: State of Oil, Gas and Mining Date: June 23, 2009 By: State of Oil, Gas and Mining Date: June 23, 2009 By: State of Oil, Gas and Mining Date: June 23, 2009 By: State of Oil, Gas and Mining Date: June 23, 2009 Date: June 23, 2009 By: State of Oil, Gas and Mining Date: June 23, 2009 Date: June 23, 2009 By: State of Oil, Gas and Mining Date: June 23, 2009 Date: June 24, 2009 Date: J	Re	equest extend to APD expirat	cion c	late.		Approved by the
Date: June 23, 2009 By: NAME (PLEASE PRINT) PHONE NUMBER TITLE						
NAME (PLEASE PRINT) PHONE NUMBER TITLE					Oi	l, Gas and Mining
NAME (PLEASE PRINT) PHONE NUMBER TITLE				_		1 22 2000
				L	ate:_	June 23, 2009
				E	By: <u> ₹</u>	red Affell
			R			
SIGNATURE DATE N/A 6/18/2009						



The Utah Division of Oil, Gas, and Mining

- State of Utah
- Department of Natural Resources

Electronic Permitting System - Sundry Notices

Request for Permit Extension Validation Well Number 43047382490000

API: 43047382490000

Well Name: RAINBOW 11-24-22-23

Location: 2018 FNL 2158 FWL QTR SENW SEC 23 TWNP 110S RNG 240E MER S

Company Permit Issued to: ENDURING RESOURCES, LLC

Date Original Permit Issued: 6/15/2006

The undersigned as owner with legal rights to drill on the property as permitted above, hereby verifies that requ

require revi	sion. Following is a	checklist of som	approved appi ne items relate	d to the appli	cation, w	s valid and doe hich should be	verified.
	ated on private land ed? 📗 Yes 📵 N		ship changed,	if so, has the	surface a	greement bee	n
	any wells been drill requirements for t			sed well whic	h would a	ffect the spaci	ng or
	here been any unit of sproposed well?		ents put in pla	ce that could	affect the	e permitting o	operation
	there been any cha the proposed locat			ling ownersh	ip, or righ	tof- way, whic	ch could
• Has tl	he approved source	of water for dri	lling changed?	🗎 Yes 📵	No		
	there been any phy je in plans from wh						uire a
• Is bo	nding still in place,	which covers thi	s proposed we	ill? 📵 Yes	No [pproved by Itah Divisior , Gas and M	of
Signature:	Alvin Arlian	Date:	6/18/2009				
Title:	Landman-Regulatory	Representing:	ENDURING RES	OURCES, LLC	Date:_	June 23, 200)9

	STATE OF UTAH		FORM 9		
	DEPARTMENT OF NATURAL RESOUR DIVISION OF OIL, GAS, AND M		5.LEASE DESIGNATION AND SERIAL NUMBER: UTU-66761		
SUNDF	RY NOTICES AND REPORTS	S ON WELLS	6. IF INDIAN, ALLOTTEE OR TRIBE NAME:		
	sals to drill new wells, significantly deepe igged wells, or to drill horizontal laterals.		7.UNIT or CA AGREEMENT NAME: ASPHALT		
1. TYPE OF WELL Gas Well			8. WELL NAME and NUMBER: RAINBOW 11-24-22-23		
2. NAME OF OPERATOR: Enduring Resources, LLC			9. API NUMBER: 43047382490000		
3. ADDRESS OF OPERATOR: 475 17th Street, Suite 1500 ,	Denver, CO, 80202 30	PHONE NUMBER: 3 350-5114 Ext	9. FIELD and POOL or WILDCAT: UNDESIGNATED		
4. LOCATION OF WELL FOOTAGES AT SURFACE: 2018 FNL 2158 FWL			COUNTY: UINTAH		
QTR/QTR, SECTION, TOWNSHI Qtr/Qtr: SENW Section: 23	P, RANGE, MERIDIAN: Township: 11.0S Range: 24.0E Meridiar	n: S	STATE: UTAH		
11. CHE	CK APPROPRIATE BOXES TO INDICA	ATE NATURE OF NOTICE, REPORT	, OR OTHER DATA		
TYPE OF SUBMISSION		TYPE OF ACTION			
	CHANGE TO PREVIOUS PLANS CHANGE WELL STATUS DEEPEN OPERATOR CHANGE PRODUCTION START OR RESUME REPERFORATE CURRENT FORMATION TUBING REPAIR WATER SHUTOFF WILDCAT WELL DETERMINATION MPLETED OPERATIONS. Clearly show all p	termination date.	CASING REPAIR CHANGE WELL NAME CONVERT WELL TYPE NEW CONSTRUCTION PLUG BACK RECOMPLETE DIFFERENT FORMATION TEMPORARY ABANDON WATER DISPOSAL ✓ APD EXTENSION OTHER: volumes, etc. Approved by the Utah Division of Oil, Gas and Mining Date: June 14, 2010 By:		
NAME (PLEASE PRINT) Alvin Arlian	PHONE NUMBE	ER TITLE Landman-Regulatory			
SIGNATURE N/A	303 350-5114	DATE 6/11/2010			



The Utah Division of Oil, Gas, and Mining

- State of Utah
- Department of Natural Resources

Electronic Permitting System - Sundry Notices

Request for Permit Extension Validation Well Number 43047382490000

API: 43047382490000

Well Name: RAINBOW 11-24-22-23

Location: 2018 FNL 2158 FWL QTR SENW SEC 23 TWNP 110S RNG 240E MER S


Company Permit Issued to: ENDURING RESOURCES, LLC

Date Original Permit Issued: 6/15/2006

The undersigned as owner with legal rights to drill on the property as permitted above, hereby verifies that requ

	tion as submitted in the p sion. Following is a check						
	ated on private land, has ed? 💮 Yes 🖲 No	the owners	ship change	ed, if so, ha	s the su	rface agreement been	
	any wells been drilled in requirements for this loc				which w	ould affect the spacing	j or
	nere been any unit or other proposed well?		ents put in	place that	could aff	ect the permitting or o	peratio
	there been any changes t the proposed location?			cluding ow	nership,	or rightof- way, which	could
• Has th	ne approved source of wa	ter for dril	ling change	ed? 🗍 Ye	es 📵 N	o	
	there been any physical one in plans from what was						re a
• Is bor	nding still in place, which			well? 📵	Yes 🗍	Approved by the No Utah Division of Oil, Gas and Min	of
	Alvin Arlian		6/11/2010		_	. I. 14 2010	
Title:	Landman-Regulatory Repr	esenting:	ENDURING	RESOURCES	, LLC D	ate: June 14, 2010	

Sig

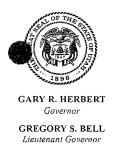

State of Utah DEPARTMENT OF NATURAL RESOURCES

MICHAEL R. STYLER Executive Director

Division of Oil, Gas and Mining

JOHN R. BAZA Division Director

June 15, 2011

Al Arlian Enduring Resources, LLC 475-17th Street, Ste. 1500 Denver, CO 80202

Re:

<u>APD Rescinded – Rainbow 11-24-22-23, Sec.23 T.11S, R.24E</u>

Uintah County, Utah API No. 43-047-38249

Dear Mr. Arlian:

The Application for Permit to Drill (APD) for the subject well was approved by the Division of Oil, Gas and Mining (Division) on June 15, 2006. On June 18, 2007, June 18, 2008, June 23, 2009 and June 14, 2010 the Division granted a one-year APD extension. On June 13, 2011, you requested that the APD be rescinded. No drilling activity at this location has been reported to the division. Therefore, approval to drill the well is hereby rescinded, effective June 13, 2011.

A new APD must be filed with this office for approval <u>prior</u> to the commencement of any future work on the subject location.

If any previously unreported operations have been performed on this well location, it is imperative that you notify the Division immediately.

Sincerely,

Diana Mason

Environmental Scientist

cc:

Well File

Bureau of Land Management, Vernal



United States Department of the Interior



BUREAU OF LAND MANAGEMENT

Green River District-Vernal Field Office 170 South 500 East Vernal, UT 84078 (435) 781-4400 Fax: (435) 781-4410 http://www.blm.gov/ut/st/en/fo/vernal.html



DEC 0 6 2011

IN REPLY REFER TO: 3160 (UTG011)

Alvin R. Arlian Enduring Resources, LLC 511-16th Street, Suite 700 Denver, CO 80202

43 047 38249

Re:

Notice of Expiration

Well No. Rainbow 11-24-22-23 Lot 4, Sec. 23, T11S, R24E Uintah County, Utah Lease No. UTU-66761

Asphalt Unit

Dear Mr. Arlian:

The Application for Permit to Drill (APD) for the above-referenced well was approved on June 7, 2007. A two (2) year extension request of the original APD was received on May 6, 2009. On May 22, 2009 the request was reviewed and the extension request was approved to June 7, 2011. According to our records, no known activity has transpired at the approved location. In view of the foregoing, this office is notifying you that the approval of the referenced application has expired. If you intend to drill at this location in the future, a new Application for Permit to Drill must be submitted.

This office requires a letter confirming that no surface disturbance has been made for this drill site. Any surface disturbance associated with the approved location of this well is to be rehabilitated. A schedule for this rehabilitation must be submitted to this office. Your cooperation in this matter is appreciated.

If you have any questions regarding this matter, please contact Cindy Severson at (435) 781-4455.

Sincerely,

Jerry Kenczka

Assistant Field Manager Lands & Mineral Resources

CC:

UDOGM

RECEIVED

DEC 14 2011

DIV. OF OIL, GÁS & MONTA

Form 3160-5 (April 2004)

UNITED STATES DEPARTMENT OF THE INTERIOR BUREAU OF LAND MANAGEMENT

OMB No. 1004-0137
Expires: March 31, 200

SUNDRY NOTICES AND REPORTS ON WELLS Do not use this form for proposals to drill or to re-enter an abandoned well. Use Form 3160 - 3 (APD) for such proposals. 5. Lease Senal No. UTU-66761 6. If Indian, Allottee or Tribe Name					
SUBMIT IN TRIPLICATE- Other instructions					
1. Type of Well ☐ ☐ ☐ ☐ ☐ Other ☐ Other	- Christoffa Side.				
2. Name of Operator Enduring Resources, LLC	8. Well Name and No. Rainbow 11-24-22-23				
3a. Address 3b. Phor	9. API Well No. e No. (include area code) 4304738249 10. Find and Pool on Fundamentary Area				
4. Location of Well (Footage, Sec., T., R., M., or Survey Description)	10. Field and Pool, or Exploratory Area undesignated				
2,018' FNL - 2,158' FWL SENW Sec 23, T11S-R24E	11. County or Parish, State				
	Uintah, Utah				
12. CHECK APPROPRIATE BOX(ES) TO INDICA					
TYPE OF SUBMISSION	TYPE OF ACTION				
Change Plans Plug ar	_ \ \ \ \ \ \ \ \ \ \ \ \ \ \ \ \ \ \ \				
Final Abandonment Notice Convert to Injection Plug B					
following completion of the involved operations. If the operation results in a resting has been completed. Final Abandonment Notices shall be filed only affectermined that the site is ready for final inspection.) This well's APD was approved 6-7-2007. Request extension of APD expiration: From: June 7, 2009 To: June 7, 2011	No. on file with BLM/BIA. Required subsequent reports shall be filed within 30 days nultiple completion or recompletion in a new interval, a Form 3160-4 shall be filed once er all requirements, including reclamation, have been completed, and the operator has				
COND	TIONS OF APPROVAL ATTACHED				
14. I hereby certify that the foregoing is true and correct Name (Printed/Typed) Alvin R. (Al) Arlian	Title Landman - Regulatory Specialist				
Signature	Date 04/24/2009				
THIS SPACE FOR FEDERA	L OR STATE OFFICE USE				
Approved by Conditions of approval, if any, are attached. Approval of this notice does not wan certify that the applicant holds legal or equitable title to those rights in the subject which would entitle the applicant to conduct operations thereon.	oleum Engineer Date MAY 2 2 2009				

(Instructions on page 2)

RECEIVED

JUN 29 2009





CONDITIONS OF APPROVAL

Enduring Resources, LLC

Notice of Intent APD Extension

Lease:

UTU-66761

Well:

Rainbow 11-24-22-23

Location:

SENW Sec 23-T11S-R24E

An extension for the referenced APD is granted with the following conditions:

- 1. The extension and APD shall expire on 6/7/2011.
- 2. No other extension shall be granted.

If you have any other questions concerning this matter, please contact Ryan Angus of this office at (435) 781-4430